CITY OF PLATTSBURGH - DRI DOWNTOWN GRANT PROGRAM

39 BRIDGE STREET, PLATTSBURGH NY, 12901

HISTORIC FRONT ELEVATION



EXISTING FRONT ELEVATION



SCOPE OF WORK

WEBSITE, https://www.nps.gov/tps/how-to-preserve/briefs.htm A. KEYNOTE: 01

- D. KEYNOTES: 01, 02, AND 03

- THAT THE EXISTING CEILING. E. KEYNOTES: 04, 05, 06, AND 07

4. DOOR WORK:

A. REPLACE (2) EXISTING EXTERIOR DOORS, THESE ARE IN ADDITION TO THE TWO EXISTING DOORS AT THE FRONT OF THE BUILDING THAT ARE TO BE PART OF THE STOREFRONT SYSTEM, AT BASE LEVEL ALONG THE EASTERN ELEVATION. WORK TO INCLUDE DEMOLITION OF EXISTING DOOR, MODIFICATIONS TO DOOR FRAME, JAMBS & HEAD. COMPLETE INSTALLATION OF INSULATED, GALVANIZED, STEEL DOORS AND HARDWARE.

B. KEYNOTE: 08

UNIT COSTS

INSTALLATION

UNIT COST #1 - BRICK REPOINTING

REPOINT 10 S.F. OF BRICK

UNIT COST #2 - BRICK REPLACEMENT REPLACEMENT OF 10 S.F. OF BRICK, BRICK TO MATCH EXISTING, BRICK TO BE

REVIEWED WITH OWNER PRIOR TO

ALTERNATE BIDS:

RECONSTRUCTION OF EXISTING CORNICE & FRONT PARAPET, THIS WORK IS TO BE DONE FOLLOWING THE GUIDANCE OUTLINED WITHIN THE TECHNICAL PRESERVATION BRIEFS 1 AND 2 WHICH CAN BE FOUND AT THE NATIONAL PARKS SERVICE WEBSITE, https://www.nps.gov/tps/how-to-preserve/briefs.htm

A. KEYNOTES: 09 AND 10

AND SOFFIT. A. KEYNOTES: 11, 12, AND 13

TRUSSES AND COLUMNS TO RE EVALUATED FOR REPLACEMENT. THERE IS SIGNIFICANT CHARRING FROM A PREVIOUS FIRE AND SOME EXISTING MEMBERS HAD BEEN MODIFIED FOR NEW EGRESS PATTERN HEIGHT. A. KEYNOTE: 14

RESTORE FLOOR OF SECOND STORY WOOD FRAMED STRUCTURE. MAKE STABLE AND FLAT. CURRENTLY THIS SPACE IS A FORMER ROOF AND HAS A SLOPE TO IT. A. KEYNOTE: 15

ALTERNATE #5: REPAIR WOODEN STAIR IN ALLEY & REFINISH.

A. KEYNOTE: 16

ALTERNATE #6:

DEMOLISH SINGLE STORY WOOD FRAMED ADDITION AT BASEMENT LEVEL. WORK TO INCLUDE: REMOVAL OF EXISTING TRAILER WITHIN STORAGE BUILDING AND EXTENSIVE REPAIR OF EXISTING WOODEN STAIR. WORK TO ALSO INCLUDE INSTALLATION OF A NEW ELECTRICAL PANEL WITHIN THE BASEMENT LEVEL, PANEL WILL BE REQUIRED TO BE REWIRED BACK TO EXISTING METER LABELED #1. DISTRIBUTION WIRING FROM EXISTING PANEL TO BE TERMINATED AND REMOVED. ALL ELECTRICAL WORK TO CONFORM TO 2020 BUILDING CODE OF NEW YORK STATE, CHAPTER 27, NFPA 70, & N.E.C. 2017.

B. KEYNOTE: 18

C. KEYNOTE: 19

ALTERNATE #7:

REPAIR, CLEAN, AND REPAINT EXISTING EXTERIOR BRICK FACADE. THIS WORK IS TO BE DONE FOLLOWING THE GUIDANCE OUTLINED WITHIN THE TECHNICAL PRESERVATION BRIEFS 1 AND 2 WHICH CAN BE FOUND AT THE NATIONAL PARKS SERVICE WEBSITE, https://www.nps.gov/tps/how-to-preserve/briefs.htm A. KEYNOTE: 20

ALTERNATE #8:

REPLACE EXISTING DOOR WITH NEW INSULATED HOLLOW METAL DOOR. DOOR TO HAVE VISION LITE AND TO HAVE A ONE HOUR FIRE RATING. WORK TO INCLUDE: FRAME, TRIM, AND HARDWARE. REPAIR PORCH STRUCTURE, PLYWOOD/OSB AS NEEDED, THE ENCLOSED STAIR IS TO BE RE-SIDED AND RE-ROOFED PER ALTERNATE #2. A. KEYNOTE: 21

SHEET LIST

SHEET NUMBER




TITLE SHEET . General GENERAL NOTES 3. LIFE SAFETY CODE ANALYSIS CODE ANALYSIS

ARCHITECTURAL & ENGINEERING DESIGN ASSOCIATES, P.C. 1246 ROUTE 3 - P.O. BOX 762 PLATTSBURGH, NY 12901 T: 518-562-1800 F: 518-562-1702 E: JAA@AEDAPC.COM

SHEET NAME	SHEET NUMBER	SHEET NAME
	4. ARCHITECTURAL	
HEET	A101	39 BRIDGE - EXISTING FLOOR PLANS
	A102	39 BRIDGE - EXISTING FLOOR PLANS
IL NOTES	A201	EXTERIOR ELEVATIONS & PHOTOS
	A202	INTERIOR ELEVATIONS & PHOTOS
NALYSIS	A203	PROPOSED DESIGN
NALYSIS	A204	PARTIAL SECOND FLOOR REFLECTED CEILING PLAN & DETAILS
	A205	PARTIAL FRAMING PLANS
	A501	DETAILS
	5. ELECTRICAL	
	E101	PARTIAL FIRST FLOOR ELECTRICAL

LOCATION MAP

AERIAL VIEW

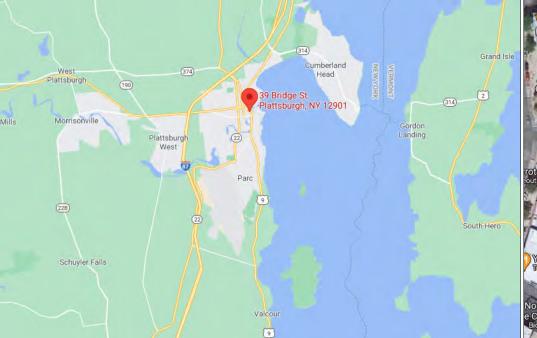




ONSTRUCTION DOCUMENT PHASE SERVICES 90%



PROJECT NO. CHECKED BY

TITLE SHEET

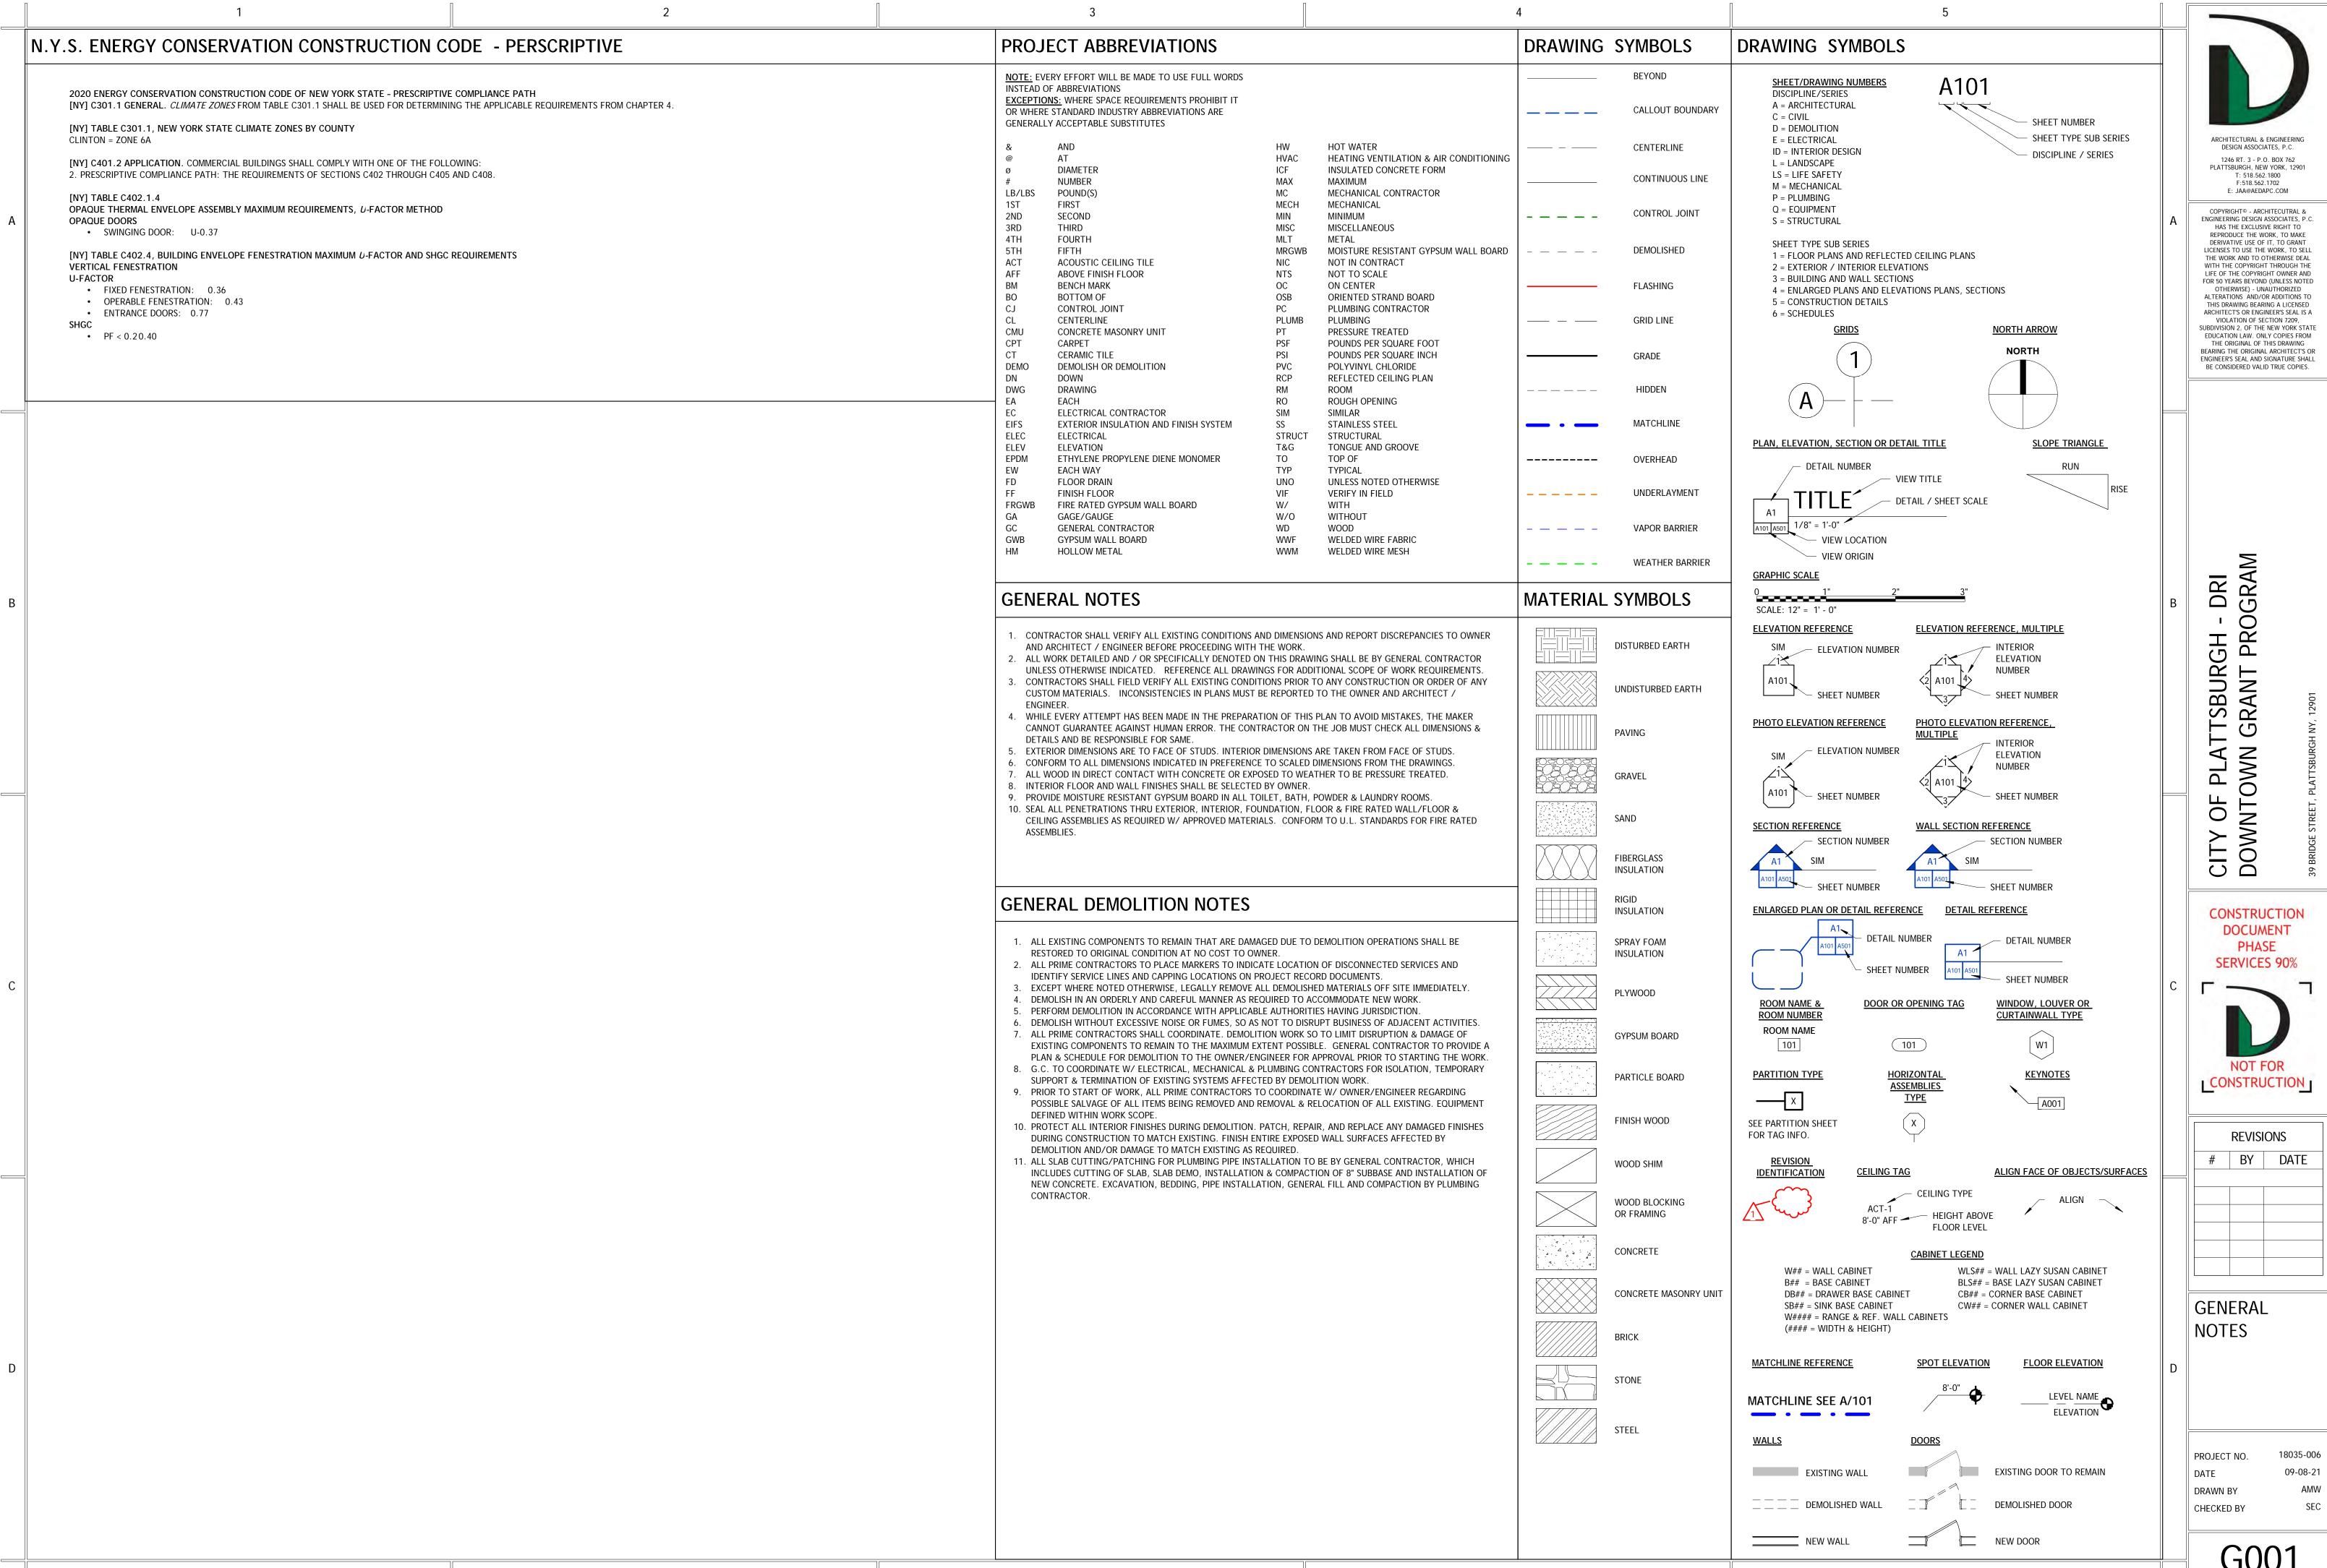

ARCHITECTURAL & ENGINEERING
DESIGN ASSOCIATES, P.C.
1246 RT. 3 - P.O. BOX 762
PLATTSBURGH, NEW YORK, 12901
T: 518.562.1800
F:518.562.1702
E: JAA@AEDAPC.COM

COPYRIGHT© - ARCHITECUTRAL &

ENGINEERING DESIGN ASSOCIATES, P.O. HAS THE EXCLUSIVE RIGHT TO REPRODUCE THE WORK, TO MAKE DERIVATIVE USE OF IT, TO GRANT LICENSES TO USE THE WORK, TO SELI THE WORK AND TO OTHERWISE DEA WITH THE COPYRIGHT THROUGH THE LIFE OF THE COPYRIGHT OWNER AND FOR 50 YEARS BEYOND (UNLESS NOTED OTHERWISE) - UNAUTHORIZED ALTERATIONS AND/OR ADDITIONS TO THIS DRAWING BEARING A LICENSED ARCHITECT'S OR ENGINEER'S SEAL IS A VIOLATION OF SECTION 7209, SUBDIVISION 2, OF THE NEW YORK STATE EDUCATION LAW ONLY COPIES FROM THE ORIGINAL OF THIS DRAWING

ENGINEER'S SEAL AND SIGNATURE SHALL

BE CONSIDERED VALID TRUE COPIES

OF PLATTSBURGH - DRI TOWN GRANT PROGRAM

CONSTRUCTION DOCUMENT PHASE SERVICES 90%

CITY DOW



BY DATE

REVISIONS

CODE ANALYSIS

PROJECT NO. 18035-006

DATE 09-08-21

DRAWN BY AMW

CHECKED BY

I S101

||[F] 907.2.10.2 Groups R-2, R-3, R-4 and I-1. Singleor multiple-station smoke alarms shall be

1. On the ceiling or wall outside of each separate sleeping area in the immediate vicinity of

UNINHABITABLE ATTICS. IN DWELLINGS OR DWELLING UNITS WITH SPLIT LEVELS AND WITHOUT AN

| | 3. IN EACH STORY WITHIN A DWELLING UNIT, INCLUDING BASEMENTS BUT NOT INCLUDING CRAWL SPACES AND

INTERVENING DOOR BETWEEN THE ADJACENT LEVELS, A SMOKE ALARM INSTALLED ON THE UPPER LEVEL SHALL SUFFICE FOR THE ADJACENT LOWER LEVEL PROVIDED THAT THE LOWER LEVEL IS LESS THAN ONE FULL STORY

| FOLLOWING LOCATIONS:

BELOW THE UPPER LEVEL.

2. IN EACH ROOM USED FOR SLEEPING PURPOSES.

BEDROOMS.

INSTALLED AND MAINTAINED IN GROUPS R-2, R-3, R-4 AND I-1 REGARDLESS OF OCCUPANT LOAD AT ALL OF THE 701.4. VERIFY IN

SEE SECTION EBC

MEETS.

FIELD IF EXISTING

2020 BUILDING CODE OF NEW YORK STATE ANALYSIS

	[F] 907.2.10.4 INSTALLATION NEAR BATHROOMS. SMOKE ALARMS SHALL BE INSTALLED NOT LESS THAN 3 FEET (914 MM) HORIZONTALLY FROM THE DOOR OR OPENING OF A BATHROOM THAT CONTAINS A BATHTUB OR SHOWER UNLESS THIS WOULD PREVENT PLACEMENT OF A SMOKE ALARM REQUIRED BY SECTION 907.2.10.1 OR 907.2.10.2.	SEE SECTION EBO 701.4. VERIFY II FIELD IF EXISTIN MEETS.
	[F] 907.2.10.5 INTERCONNECTION. WHERE MORE THAN ONE SMOKE ALARM IS REQUIRED TO BE INSTALLED WITHIN AN INDIVIDUAL DWELLING UNIT OR SLEEPING UNIT IN GROUP R OR I-1 OCCUPANCIES, THE SMOKE ALARMS SHALL BE INTERCONNECTED IN SUCH A MANNER THAT THE ACTIVATION OF ONE ALARM WILL ACTIVATE ALL OF THE ALARMS IN THE INDIVIDUAL UNIT. PHYSICAL INTERCONNECTION OF SMOKE ALARMS SHALL NOT BE REQUIRED WHERE LISTED WIRELESS ALARMS ARE INSTALLED AND ALL ALARMS SOUND UPON ACTIVATION OF ONE ALARM. THE ALARM SHALL BE CLEARLY AUDIBLE IN ALL BEDROOMS OVER BACKGROUND NOISE LEVELS WITH ALL INTERVENING DOORS CLOSED.	SEE SECTION EBO 701.4. VERIFY II FIELD IF EXISTING MEETS.
	[F] 907.2.10.6 POWER SOURCE. IN NEW CONSTRUCTION, REQUIRED SMOKE ALARMS SHALL RECEIVE THEIR PRIMARY POWER FROM THE BUILDING WIRING WHERE SUCH WIRING IS SERVED FROM A COMMERCIAL SOURCE AND SHALL BE EQUIPPED WITH A BATTERY BACKUP. SMOKE ALARMS WITH INTEGRAL STROBES THAT ARE NOT EQUIPPED WITH BATTERY BACKUP SHALL BE CONNECTED TO AN EMERGENCY ELECTRICAL SYSTEM IN ACCORDANCE WITH SECTION 2702. SMOKE ALARMS SHALL EMIT A SIGNAL WHEN THE BATTERIES ARE LOW. WIRING SHALL BE PERMANENT AND WITHOUT A DISCONNECTING SWITCH OTHER THAN AS REQUIRED FOR OVERCURRENT PROTECTION. EXCEPTION: SMOKE ALARMS ARE NOT REQUIRED TO BE EQUIPPED WITH BATTERY BACKUP WHERE THEY ARE CONNECTED TO AN EMERGENCY ELECTRICAL SYSTEM THAT COMPLIES WITH SECTION 2702.	SEE SECTION EBO 701.4. VERIFY IN FIELD IF EXISTING MEETS. EXEMPTION ALLOWED FOR BATTERY BACKUL DEVICES.
CHAPTER 10: MEANS OF EGRESS	CONNECTED TO AN EINERGENCT ELECTRICAL STSTEW THAT COWFELLS WITH SECTION 2702.	
TABLE 1006.3.3(1) STORIES WITH ONE EXIT OR ACCESS TO ONE EXIT FOR R-2 OCCUPANCIES	STORY = BASEMENT, FIRST, SECOND OR THIRD STORY ABOVE GRADE PLANE OCCUPANCY = R-2A, B MAXIMUM NUMBER OF DWELLING UNITS = 4 DWELLING UNITS MAXIMUM COMMON PATH OF EGRESS TRAVEL DISTANCE = 125 FEET FOR SI: 1 FOOT = 3048 MM. NP = NOT PERMITTED. NA = NOT APPLICABLE.	NA?
	A. BUILDINGS CLASSIFIED AS GROUP R-2 EQUIPPED THROUGHOUT WITH AN AUTOMATIC SPRINKLER SYSTEM IN ACCORDANCE WITH SECTION 903.3.1.1 OR 903.3.1.2 AND PROVIDED WITH EMERGENCY ESCAPE AND RESCUE OPENINGS IN ACCORDANCE WITH SECTION 1030. B. THIS TABLE IS USED FOR R-2 OCCUPANCIES CONSISTING OF DWELLING UNITS. FOR R-2 OCCUPANCIES CONSISTING OF SLEEPING UNITS, USE TABLE 1006.3.3(2).	
	1023.7 INTERIOR EXIT STAIRWAY AND RAMP EXTERIOR WALLS. EXTERIOR WALLS OF THE INTERIOR EXIT STAIRWAY OR RAMP SHALL COMPLY WITH THE REQUIREMENTS OF SECTION 705 FOR EXTERIOR WALLS. WHERE NONRATED WALLS OR UNPROTECTED OPENINGS ENCLOSE THE EXTERIOR OF THE STAIRWAY OR RAMPS AND THE WALLS OR OPENINGS ARE EXPOSED BY OTHER PARTS OF THE BUILDING AT AN ANGLE OF LESS THAN 180 DEGREES (3.14 RAD), THE BUILDING EXTERIOR WALLS WITHIN 10 FEET (3048 MM) HORIZONTALLY OF A NONRATED WALL OR UNPROTECTED OPENING SHALL HAVE A FIRE-RESISTANCE RATING OF NOT LESS THAN 1 HOUR. OPENINGS WITHIN SUCH EXTERIOR WALLS SHALL BE PROTECTED BY OPENING PROTECTIVES HAVING A FIRE PROTECTION RATING OF NOT LESS THAN 3/4 HOUR. THIS CONSTRUCTION SHALL EXTEND VERTICALLY FROM THE GROUND TO A POINT 10 FEET (3048 MM) ABOVE THE TOP MOST LANDING OF THE STAIRWAY OR RAMP, OR TO THE ROOF LINE, WHICHEVER IS LOWER.	SEE SECTION 1027.6. IS THIS PROVIDED?
Section 1027 Exterior Exit Stairways and Ramps	1027.1 EXTERIOR EXIT STAIRWAYS AND RAMPS. EXTERIOR EXIT STAIRWAYS AND RAMPS SERVING AS AN ELEMENT OF A REQUIRED MEANS OF EGRESS SHALL COMPLY WITH THIS SECTION.	
	1027.2 USE IN A MEANS OF EGRESS. EXTERIOR EXIT STAIRWAYS SHALL NOT BE USED AS AN ELEMENT OF A REQUIRED MEANS OF EGRESS FOR GROUP I-2 OCCUPANCIES. FOR OCCUPANCIES IN OTHER THAN GROUP I-2, EXTERIOR EXIT STAIRWAYS AND RAMPS SHALL BE PERMITTED AS AN ELEMENT OF A REQUIRED MEANS OF EGRESS FOR BUILDINGS NOT EXCEEDING SIX STORIES ABOVE GRADE PLANE OR THAT ARE NOT HIGH-RISE BUILDINGS.	PROVIDED
	1027.3 OPEN SIDE. EXTERIOR EXIT STAIRWAYS AND RAMPS SERVING AS AN ELEMENT OF A REQUIRED MEANS OF EGRESS SHALL BE OPEN ON NOT LESS THAN ONE SIDE, EXCEPT FOR REQUIRED STRUCTURAL COLUMNS, BEAMS, HANDRAILS AND GUARDS. AN OPEN SIDE SHALL HAVE NOT LESS THAN 35 SQUARE FEET (3.3 M2) OF AGGREGATE OPEN AREA ADJACENT TO EACH FLOOR LEVEL AND THE LEVEL OF EACH INTERMEDIATE LANDING. THE REQUIRED OPEN AREA SHALL BE LOCATED NOT LESS THAN 42 INCHES (1067 MM) ABOVE THE ADJACENT FLOOR OR LANDING LEVEL.	PROVIDED?
	1027.4 SIDE YARDS. THE OPEN AREAS ADJOINING EXTERIOR EXIT STAIRWAYS OR RAMPS SHALL BE EITHER YARDS, COURTS OR PUBLIC WAYS; THE REMAINING SIDES ARE PERMITTED TO BE ENCLOSED BY THE EXTERIOR WALLS OF THE BUILDING. 1027.5 LOCATION. EXTERIOR EXIT STAIRWAYS AND RAMPS SHALL HAVE A MINIMUM FIRE SEPARATION DISTANCE OF 10 FEET (3048 MM) MEASURED AT RIGHT ANGLES FROM THE EXTERIOR EDGE OF THE STAIRWAY OR RAMPS, INCLUDING LANDINGS, TO:	
	 ADJACENT LOT LINES. OTHER PORTIONS OF THE BUILDING. OTHER BUILDINGS ON THE SAME LOT UNLESS THE ADJACENT BUILDING EXTERIOR WALLS AND OPENINGS ARE PROTECTED IN ACCORDANCE WITH SECTION 705 BASED ON FIRE SEPARATION DISTANCE. FOR THE PURPOSES OF THIS SECTION, OTHER PORTIONS OF THE BUILDING SHALL BE TREATED AS SEPARATE BUILDINGS. 	
	1027.6 EXTERIOR EXIT STAIRWAY AND RAMP PROTECTION. EXTERIOR EXIT STAIRWAYS AND RAMPS SHALL BE SEPARATED FROM THE INTERIOR OF THE BUILDING AS REQUIRED IN SECTION 1023.2. OPENINGS SHALL BE LIMITED TO THOSE NECESSARY FOR EGRESS FROM NORMALLY OCCUPIED SPACES. WHERE A VERTICAL PLANE PROJECTING FROM THE EDGE OF AN EXTERIOR EXIT STAIRWAY OR RAMP AND LANDINGS IS EXPOSED BY OTHER PARTS OF THE BUILDING AT AN ANGLE OF LESS THAN 180 DEGREES (3.14 RAD), THE EXTERIOR WALL SHALL BE RATED IN ACCORDANCE WITH SECTION 1023.7. EXCEPTIONS: 1. SEPARATION FROM THE INTERIOR OF THE BUILDING IS NOT REQUIRED FOR OCCUPANCIES, OTHER THAN	DOES IT EXIT TO THE FIRST STORY ABOVE GRADE PLANE? IF NOT, SEE SECTION 1023.7
SECTION 1030 EMERGENCY	THOSE IN GROUP R-1 OR R-2, IN BUILDINGS THAT ARE NOT MORE THAN TWO STORIES ABOVE GRADE PLANE WHERE A LEVEL OF EXIT DISCHARGE SERVING SUCH OCCUPANCIES IS THE FIRST STORY ABOVE GRADE PLANE. 1030.1 GENERAL. IN ADDITION TO THE MEANS OF EGRESS REQUIRED BY THIS CHAPTER, EMERGENCY ESCAPE AND RESCUE OPENINGS SHALL BE PROVIDED IN THE FOLLOWING OCCUPANCIES:	SEE TABLE 1006.3.3(1)
ESCAPE AND RESCUE	1. GROUP R-2 OCCUPANCIES LOCATED IN STORIES WITH ONLY ONE EXIT OR ACCESS TO ONLY ONE EXIT AS PERMITTED BY TABLES 1006.3.3(1) AND 1006.3.3(2). 1030.2 MINIMUM SIZE. EMERGENCY ESCAPE AND RESCUE OPENINGS SHALL HAVE A MINIMUM NET CLEAR OPENING OF 5.7 SQUARE FEET (0.53 M2).	SEE EBCNYS SECTION 702.5,
	EXCEPTION: THE MINIMUM NET CLEAR OPENING FOR GRADEFLOOR EMERGENCY ESCAPE AND RESCUE OPENINGS SHALL BE 5 SQUARE FEET (0.46 M2). 1030.2.1 MINIMUM DIMENSIONS. THE MINIMUM NET CLEAR OPENING HEIGHT DIMENSION SHALL BE 24 INCHES (610 MM). THE MINIMUM NET CLEAR OPENING WIDTH DIMENSION SHALL BE 20 INCHES (508 MM). THE NET	EXEMPT
	CLEAR OPENING DIMENSIONS SHALL BE THE RESULT OF NORMAL OPERATION OF THE OPENING. 1030.3 MAXIMUM HEIGHT FROM FLOOR. EMERGENCY ESCAPE AND RESCUE OPENINGS SHALL HAVE THE BOTTOM OF THE CLEAR OPENING NOT GREATER THAN 44 INCHES (1118 MM) MEASURED FROM THE FLOOR.	SEE EBCNYS SECTION 702.5, EXEMPT
	1030.4 WINDOW WELLS. AN EMERGENCY ESCAPE AND RESCUE OPENING WITH A FINISHED SILL HEIGHT BELOW THE ADJACENT GROUND LEVEL SHALL BE PROVIDED WITH A WINDOW WELL IN ACCORDANCE WITH SECTIONS 1030.4.1 AND 1030.4.2. 1030.4.1 MINIMUM SIZE. THE MINIMUM HORIZONTAL AREA OF THE WINDOW WELL SHALL BE 9 SQUARE FEET	SEE EBCNYS SECTION 702.5, EXEMPT

ARCHITECTURAL & ENGINEERING

DESIGN ASSOCIATES, P.C. 1246 RT. 3 - P.O. BOX 762 PLATTSBURGH, NEW YORK, 12901 T: 518.562.1800 F:518.562.1702 E: JAA@AEDAPC.COM

COPYRIGHT® - ARCHITECUTRAL & ENGINEERING DESIGN ASSOCIATES, P.C HAS THE EXCLUSIVE RIGHT TO REPRODUCE THE WORK, TO MAKE DERIVATIVE USE OF IT, TO GRANT LICENSES TO USE THE WORK, TO SELI THE WORK AND TO OTHERWISE DEA WITH THE COPYRIGHT THROUGH THE LIFE OF THE COPYRIGHT OWNER AND FOR 50 YEARS BEYOND (UNLESS NOTED OTHERWISE) - UNAUTHORIZED ALTERATIONS AND/OR ADDITIONS TO THIS DRAWING BEARING A LICENSED

ARCHITECT'S OR ENGINEER'S SEAL IS A VIOLATION OF SECTION 7209, SUBDIVISION 2, OF THE NEW YORK STATE EDUCATION LAW. ONLY COPIES FROM THE ORIGINAL OF THIS DRAWING ENGINEER'S SEAL AND SIGNATURE SHALL BE CONSIDERED VALID TRUE COPIES.

FTSBURGH - DRI GRANT PROGRAM **PLATT** 0F CITY

CONSTRUCTION DOCUMENT




	REVIS	IONS	
INE VISIONS			
	BY	DATE	

ANALYSIS

18035-006 09-08-21 DRAWN BY

CHECKED BY

JCB SEC

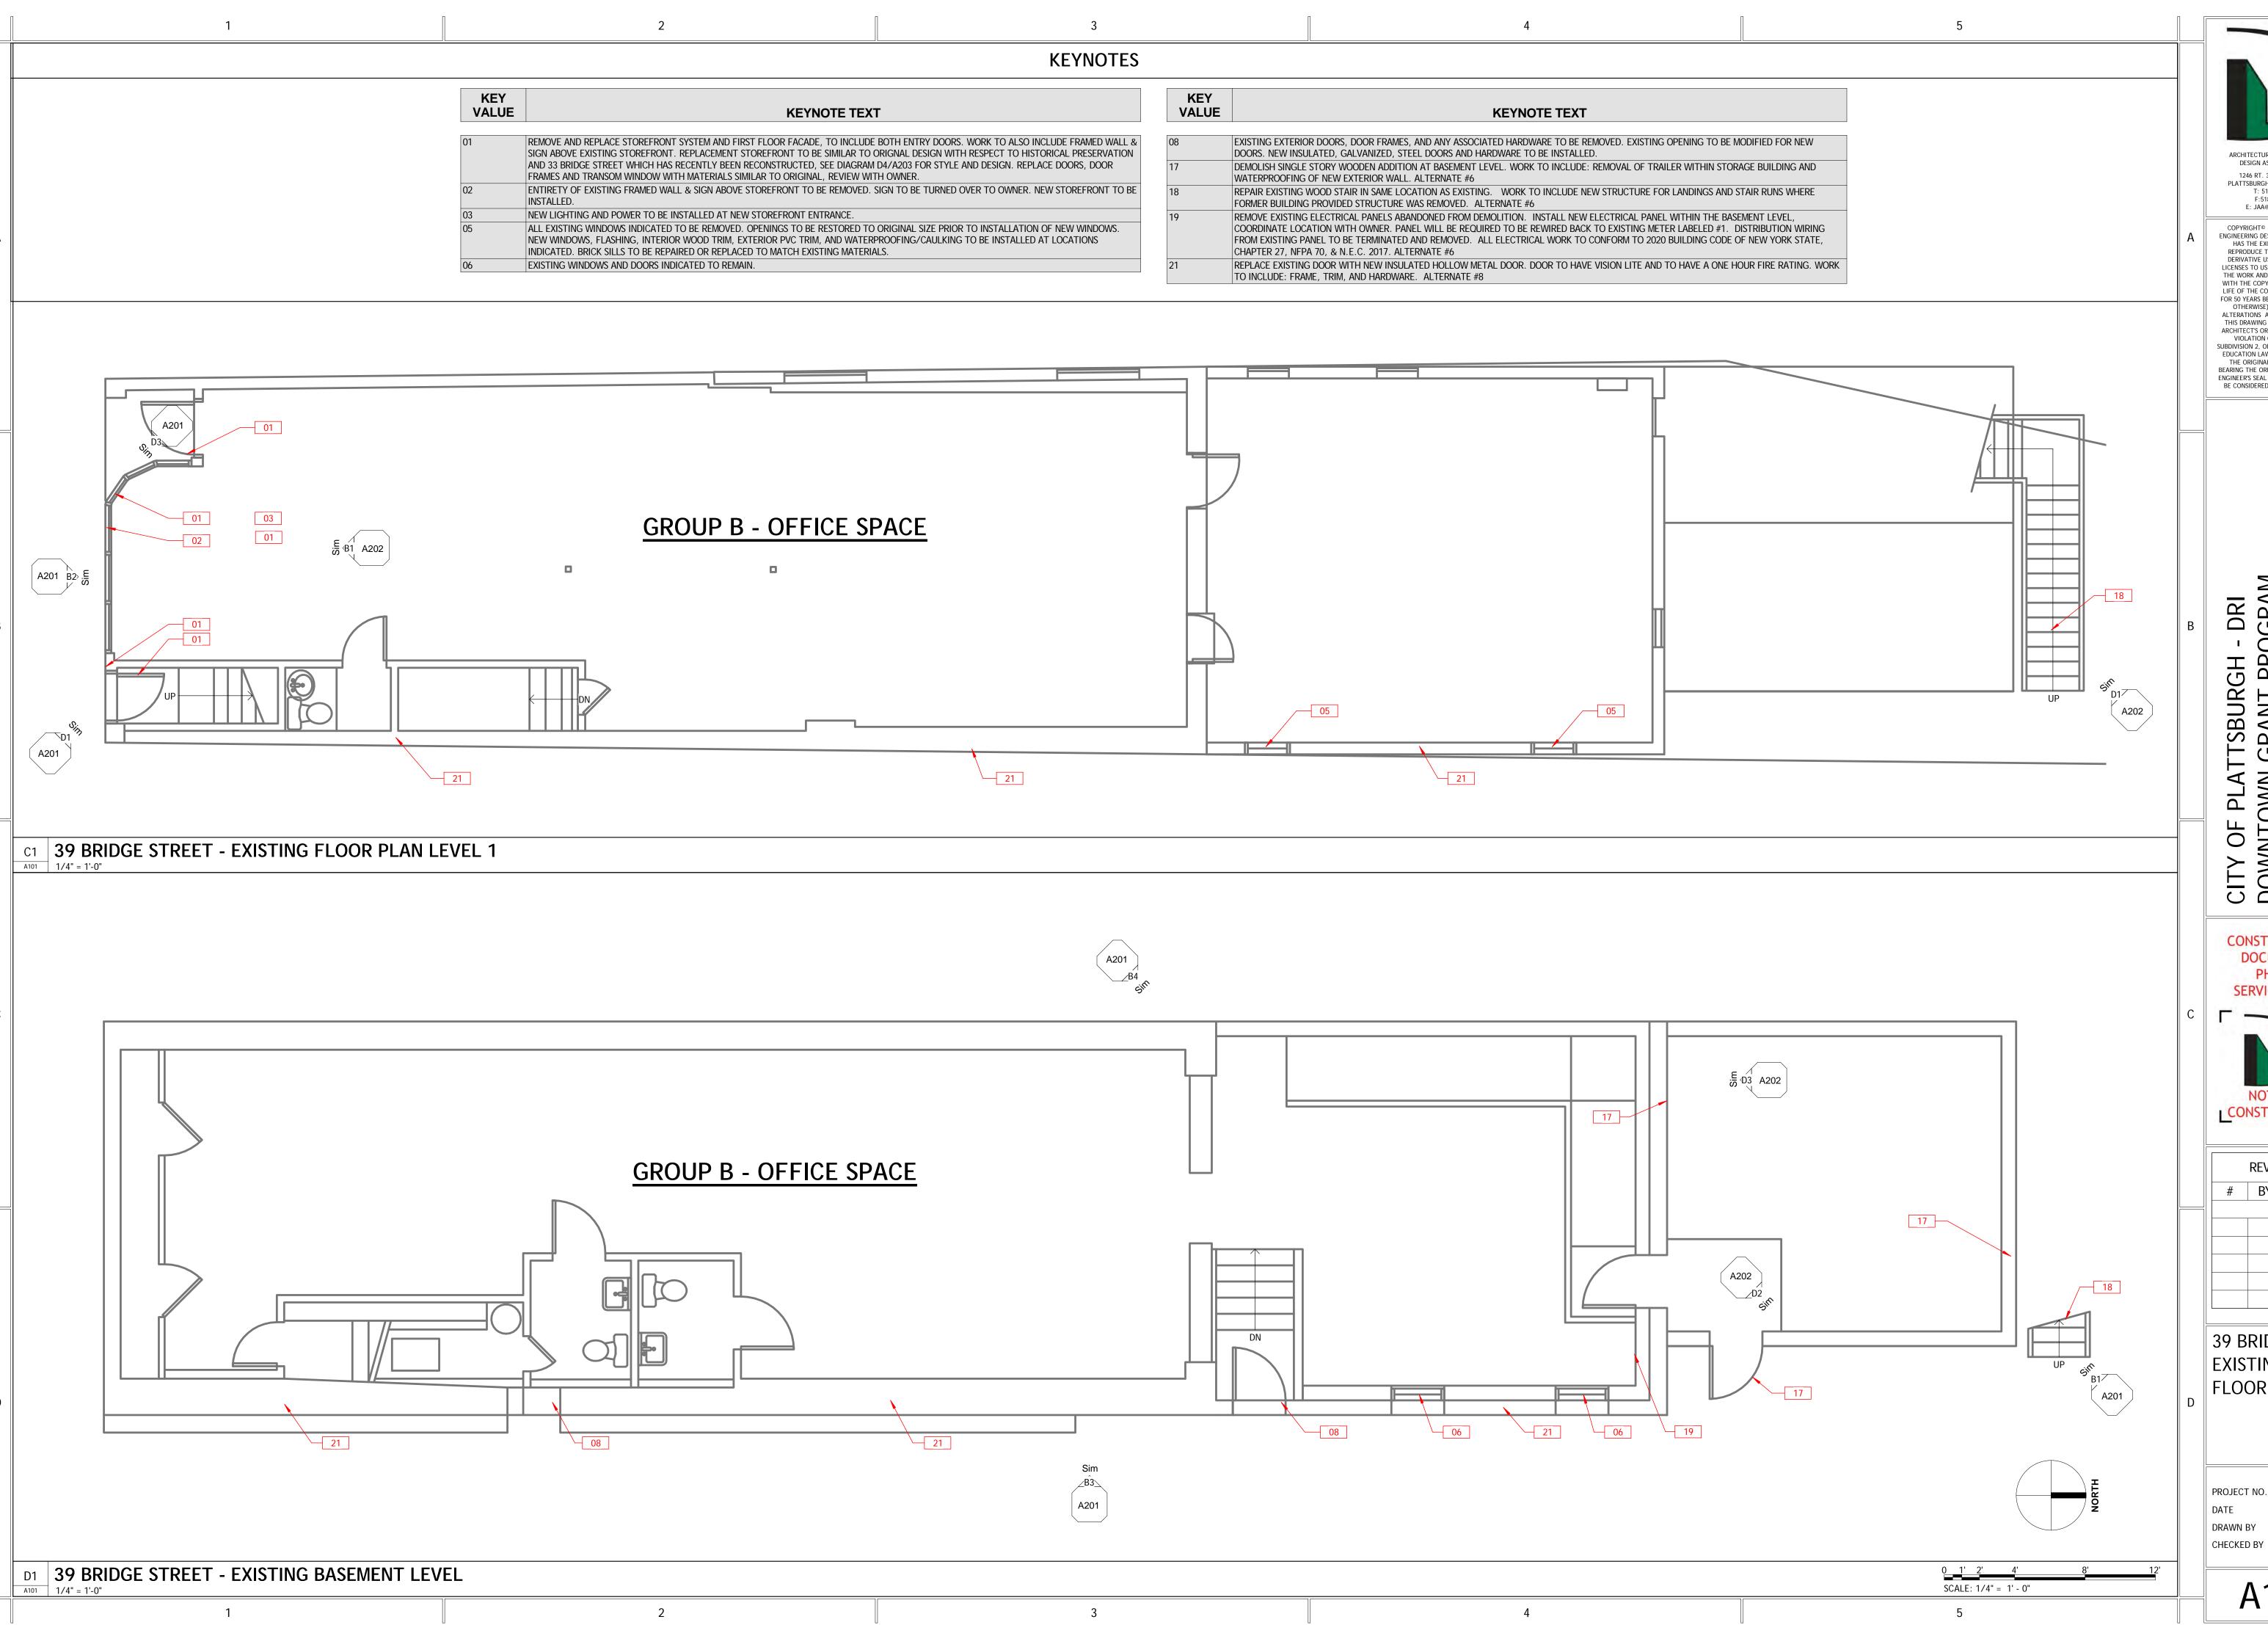

ARCHITECTURAL & ENGINEERING

DESIGN ASSOCIATES, P.C. 1246 RT. 3 - P.O. BOX 762 PLATTSBURGH, NEW YORK, 12901 T: 518.562.1800 F:518.562.1702 E: JAA@AEDAPC.COM

COPYRIGHT© - ARCHITECUTRAL & ENGINEERING DESIGN ASSOCIATES, P.C. HAS THE EXCLUSIVE RIGHT TO REPRODUCE THE WORK, TO MAKE DERIVATIVE USE OF IT, TO GRANT LICENSES TO USE THE WORK, TO SELL

THE WORK AND TO OTHERWISE DEAL WITH THE COPYRIGHT THROUGH THE LIFE OF THE COPYRIGHT OWNER AND FOR 50 YEARS BEYOND (UNLESS NOTED OTHERWISE) - UNAUTHORIZED ALTERATIONS AND/OR ADDITIONS TO THIS DRAWING BEARING A LICENSED

ARCHITECT'S OR ENGINEER'S SEAL IS A VIOLATION OF SECTION 7209,

EDUCATION LAW. ONLY COPIES FROM THE ORIGINAL OF THIS DRAWING ENGINEER'S SEAL AND SIGNATURE SHALL BE CONSIDERED VALID TRUE COPIES.

OF PLATTSBURGH - DRI NTOWN GRANT PROGRAM CITY

CONSTRUCTION DOCUMENT


SERVICES 90% CONSTRUCTION

REVISIONS # BY DATE

39 BRIDGE -EXISTING FLOOR PLANS

09-08-21

A101

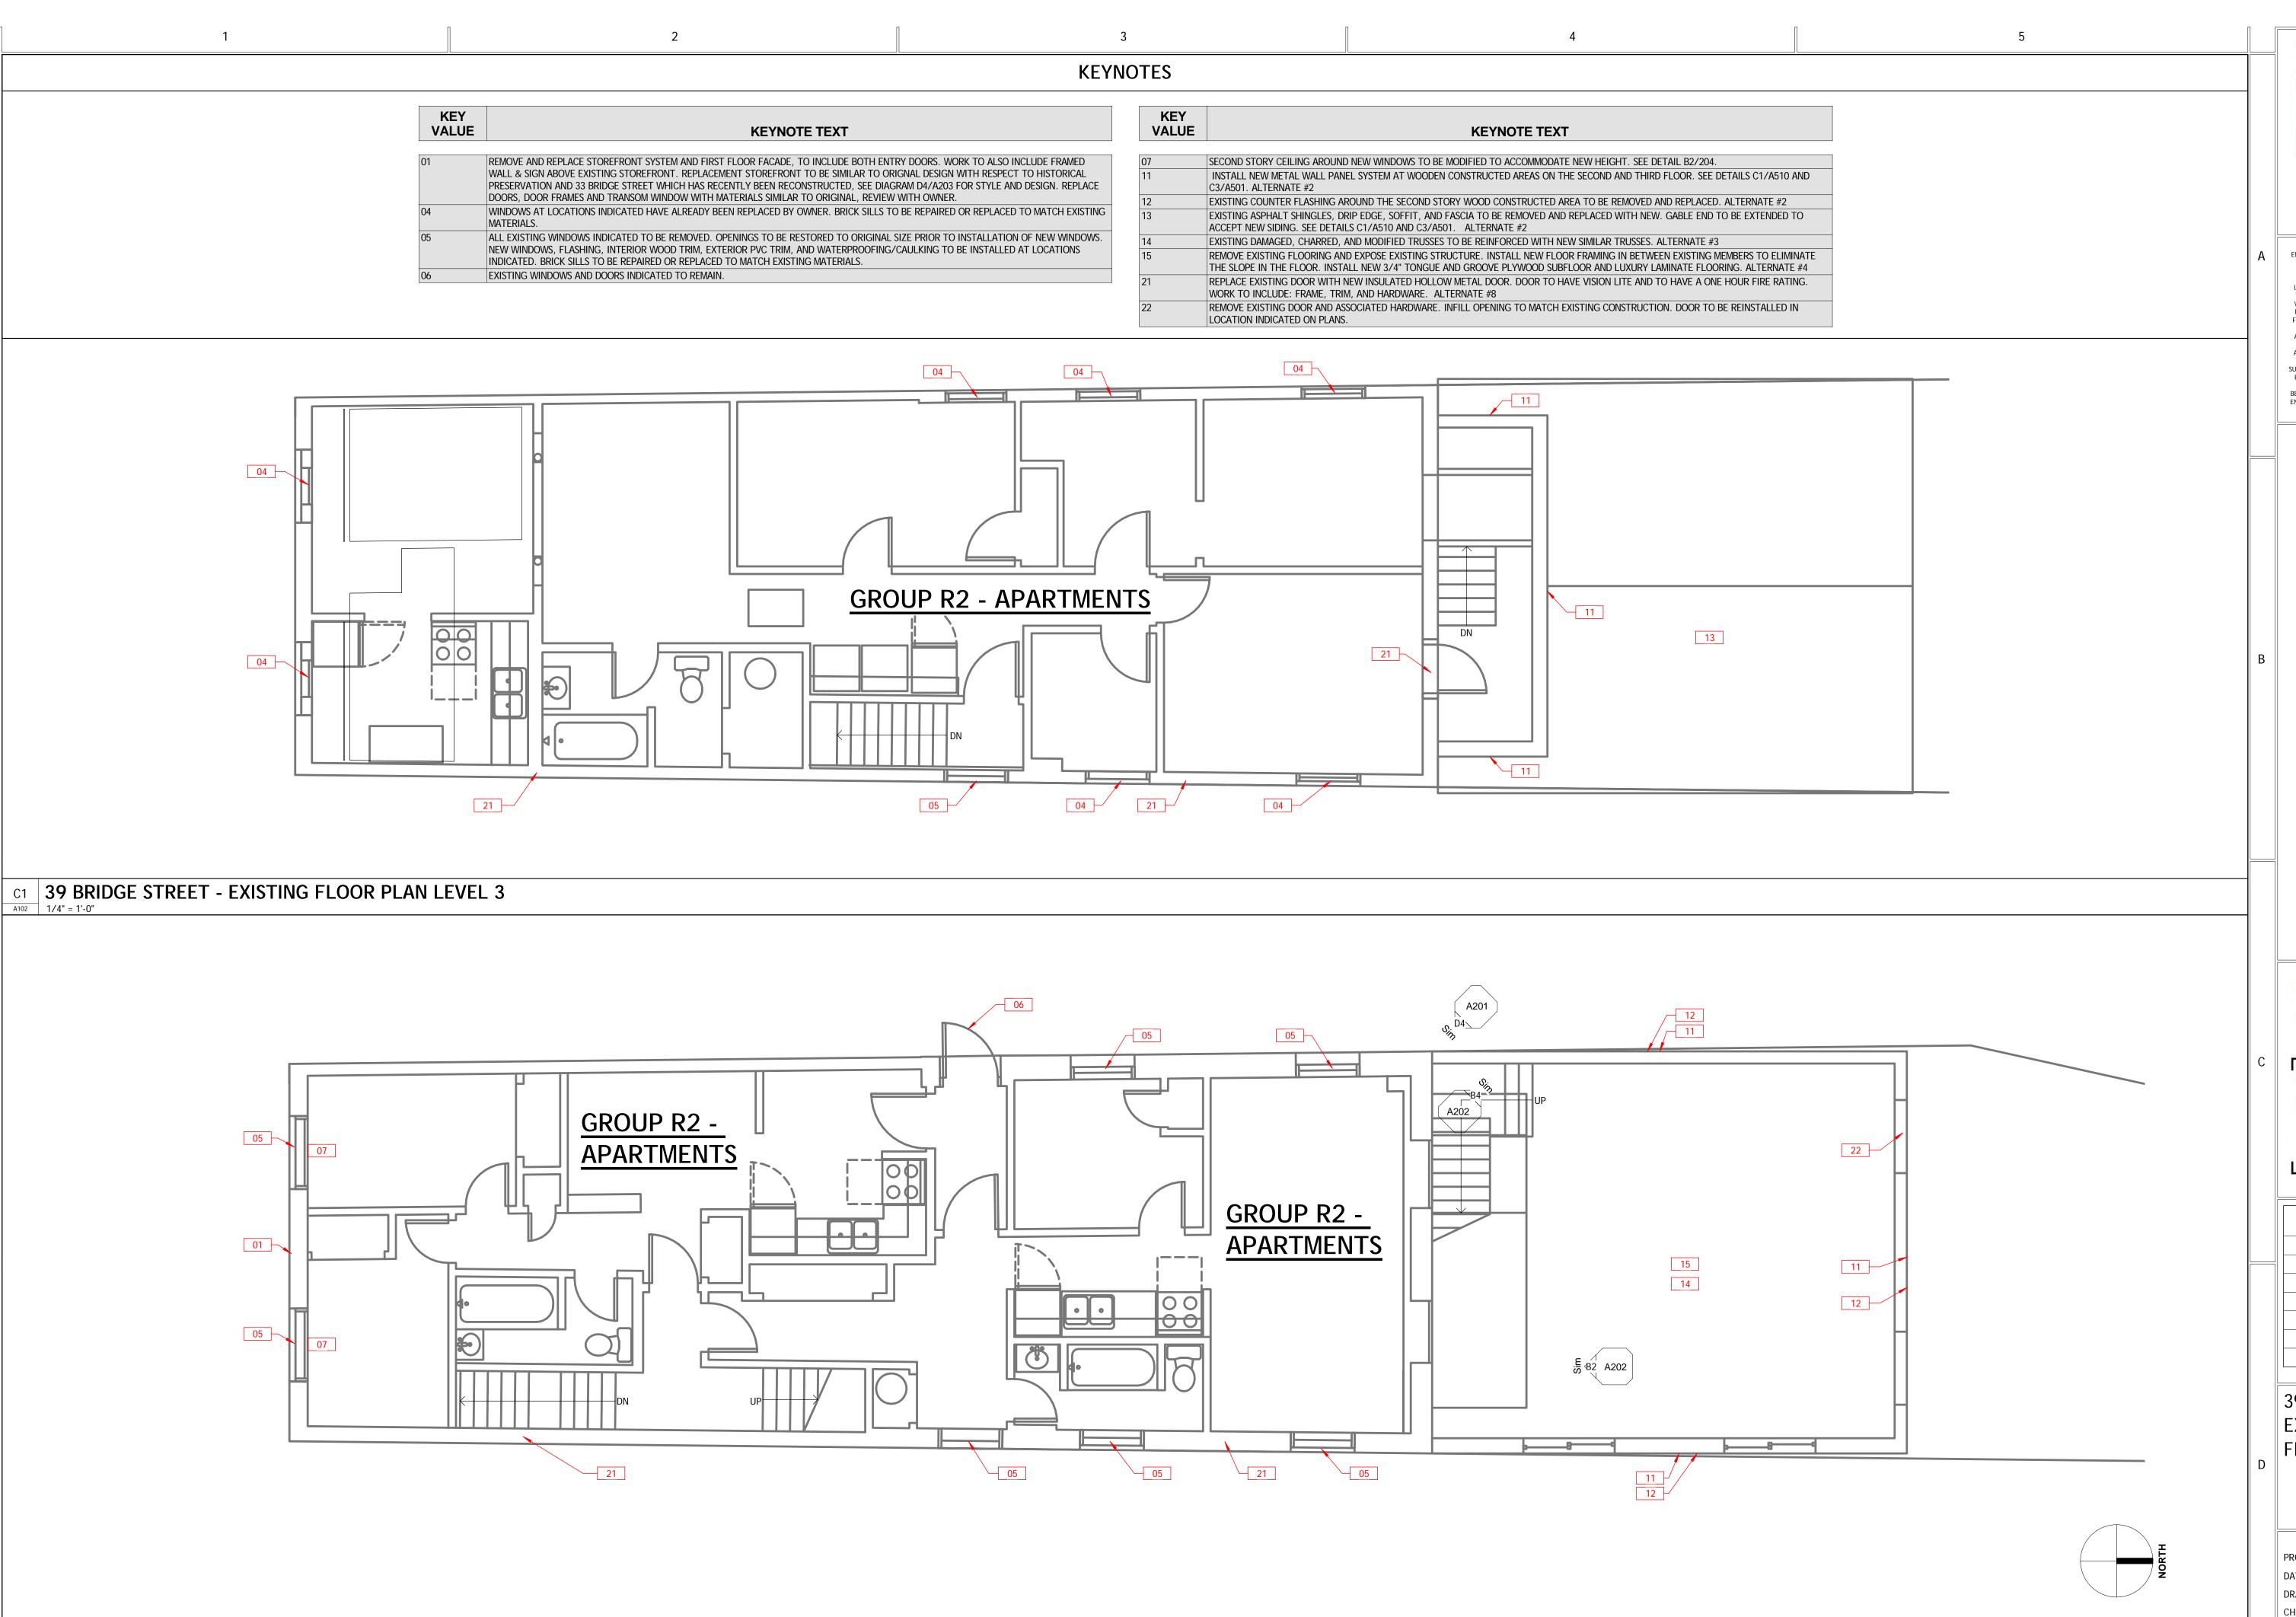

D1 39 BRIDGE STREET - EXISTING FLOOR PLAN LEVEL 2

ARCHITECTURAL & ENGINEERING
DESIGN ASSOCIATES, P.C.

ARCHITECTURAL & ENGINEERING DESIGN ASSOCIATES, P.C.

1246 RT. 3 - P.O. BOX 762
PLATTSBURGH, NEW YORK, 12901
T: 518.562.1800
F:518.562.1702
E: JAA@AEDAPC.COM

COPYRIGHT® - ARCHITECUTRAL &
ENGINEERING DESIGN ASSOCIATES, P.C.
HAS THE EXCLUSIVE RIGHT TO

HAS THE EXCLUSIVE RIGHT TO
REPRODUCE THE WORK, TO MAKE
DERIVATIVE USE OF IT, TO GRANT
LICENSES TO USE THE WORK, TO SELL
THE WORK AND TO OTHERWISE DEAL
WITH THE COPYRIGHT THROUGH THE
LIFE OF THE COPYRIGHT OWNER AND
FOR 50 YEARS BEYOND (UNLESS NOTED

OTHERWISE) - UNAUTHORIZED
ALTERATIONS AND/OR ADDITIONS TO
THIS DRAWING BEARING A LICENSED
ARCHITECT'S OR ENGINEER'S SEAL IS A
VIOLATION OF SECTION 7209,
SUBDIVISION 2, OF THE NEW YORK STATE
EDUCATION LAW. ONLY COPIES FROM

SUBDIVISION 2, OF THE NEW YORK STATE
EDUCATION LAW. ONLY COPIES FROM
THE ORIGINAL OF THIS DRAWING
BEARING THE ORIGINAL ARCHITECT'S OR
ENGINEER'S SEAL AND SIGNATURE SHALL
BE CONSIDERED VALID TRUE COPIES.

CITY OF PLATTSBURGH - DRI DOWNTOWN GRANT PROGRAM

CONSTRUCTION DOCUMENT PHASE

SERVICES 90%

NOT FOR
CONSTRUCTION

REVISIONS
BY DATE

39 BRIDGE -

EXISTING FLOOR PLANS


PROJECT NO. 18035-006


DATE 09-08-21

DRAWN BY AMW

CHECKED BY SEC

0 1' 2' 4' SCALE: 1/4" = 1' - 0" A102

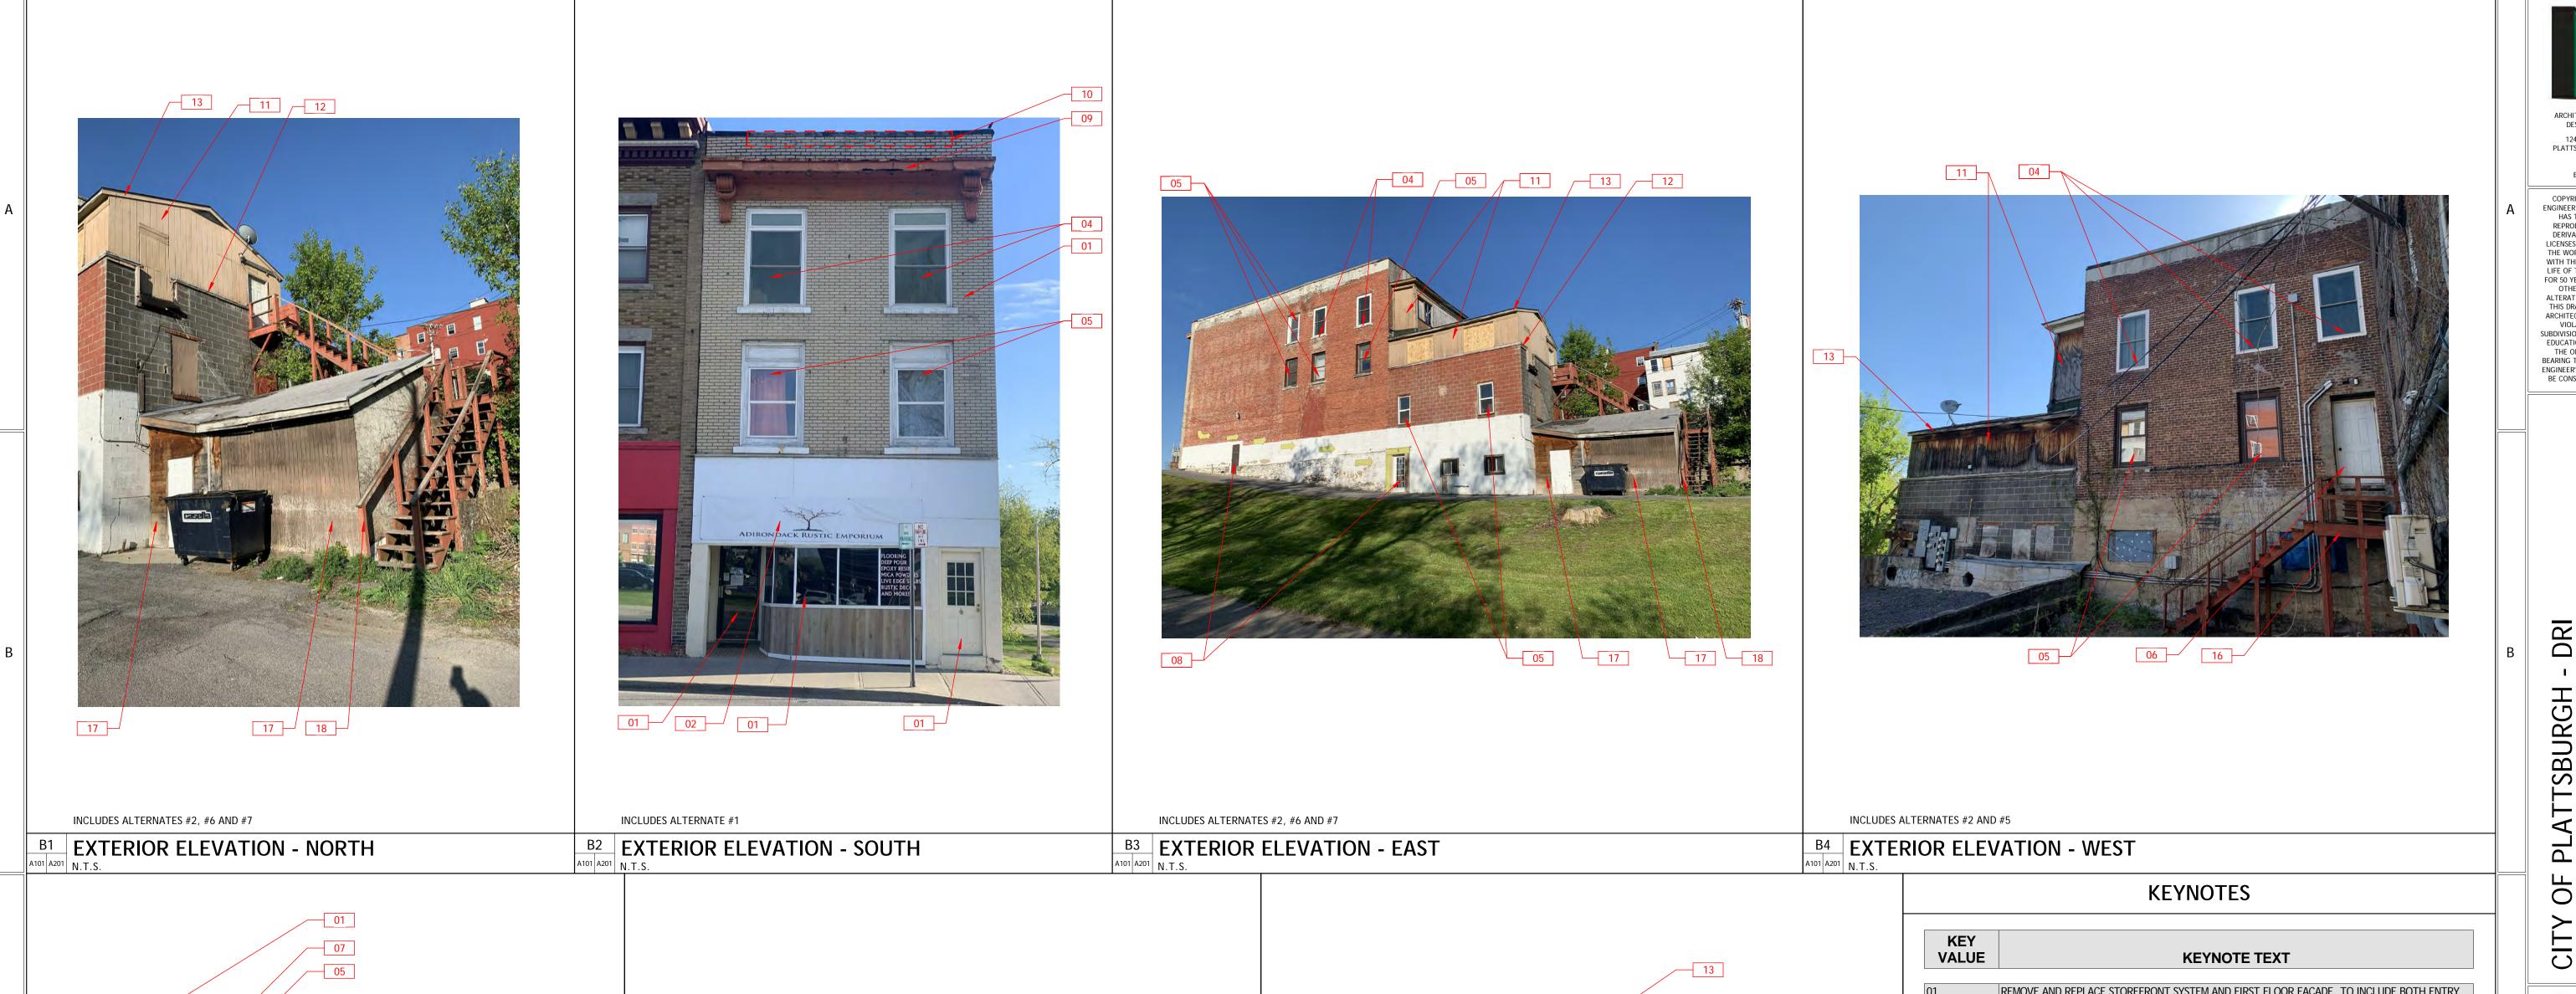

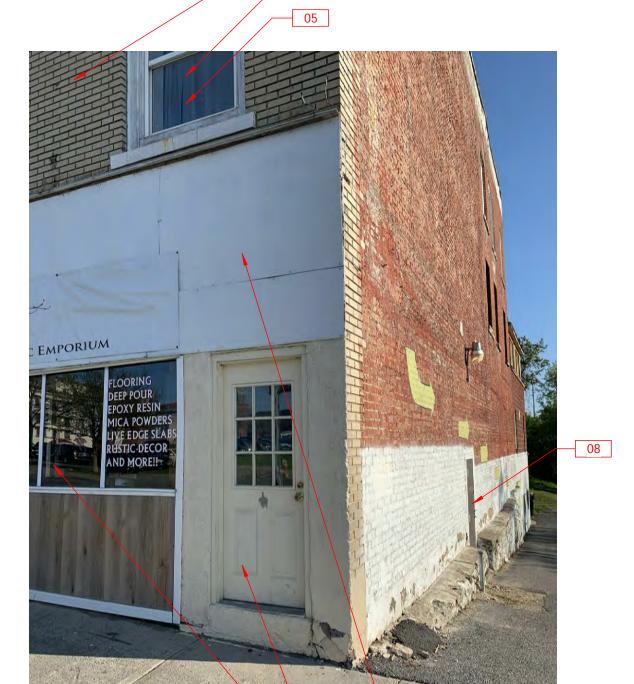

01 02





INCLUDES ALTERNATE #2 AND #5

D1 EXTERIOR DOOR
N.T.S. D3 STOREFRONT N.T.S.

2

D4 EXTERIOR FLASHING N.T.S.

KEY VALUE	KEYNOTE TEXT		
01	REMOVE AND REPLACE STOREFRONT SYSTEM AND FIRST FLOOR FACADE, TO INCLUDE BOTH ENTRY DOORS. WORK TO ALSO INCLUDE FRAMED WALL & SIGN ABOVE EXISTING STOREFRONT. REPLACEMENT STOREFRONT TO BE SIMILAR TO ORIGNAL DESIGN WITH RESPECT TO HISTORICAL PRESERVATION AND 33 BRIDGE STREET WHICH HAS RECENTLY BEEN RECONSTRUCTED, SEE DIAGRAM D4/A203 FOR STYLE AND DESIGN. REPLACE DOORS, DOOR FRAMES AND TRANSOM WINDOW WITH MATERIALS SIMILAR TO ORIGINAL, REVIEW WITH OWNER.		
02	ENTIRETY OF EXISTING FRAMED WALL & SIGN ABOVE STOREFRONT TO BE REMOVED. SIGN TO BE TURNED OVER TO OWNER. NEW STOREFRONT TO BE INSTALLED.		
04	WINDOWS AT LOCATIONS INDICATED HAVE ALREADY BEEN REPLACED BY OWNER. BRICK SILLS TO BE REPAIRED OR REPLACED TO MATCH EXISTING MATERIALS.		
05	ALL EXISTING WINDOWS INDICATED TO BE REMOVED. OPENINGS TO BE RESTORED TO ORIGINAL SIZE PRIOR TO INSTALLATION OF NEW WINDOWS. NEW WINDOWS, FLASHING, INTERIOR WOOD TRIM, EXTERIOR PVC TRIM, AND WATERPROOFING/CAULKING TO BE INSTALLED AT LOCATIONS INDICATED. BRICK SILLS TO BE REPAIRED OR REPLACED TO MATCH EXISTING MATERIALS.		
06	EXISTING WINDOWS AND DOORS INDICATED TO REMAIN.		
07	SECOND STORY CEILING AROUND NEW WINDOWS TO BE MODIFIED TO ACCOMMODATE NEW HEIGHT. SEE DETAIL B2/204.		
08	EXISTING EXTERIOR DOORS, DOOR FRAMES, AND ANY ASSOCIATED HARDWARE TO BE REMOVED. EXISTING OPENING TO BE MODIFIED FOR NEW DOORS. NEW INSULATED, GALVANIZED, STEEL DOORS AND HARDWARE TO BE INSTALLED.		
09	RECONSTRUCT EXISTING CORNICE FOLLOWING THE GUIDANCE OUTLINED WITHIN THE TECHNICAL PRESERVATION BRIEFS 1 AND 2. TO BE PAINTED WHITE. ALTERNATE #1		
10	REMOVE PORTION OF EXISTING FRONT PARAPET AS SHOWN. WORK TO INCLUDE NEW PARAPET CAP FLASHING AND REINSURANCE OF WATERPROOFING AT EXISTING ROOF AND PARAPET WALL. ALTERNATE #1		
11	INSTALL NEW METAL WALL PANEL SYSTEM AT WOODEN CONSTRUCTED AREAS ON THE SECOND AND THIRD FLOOR. SEE DETAILS C1/A510 AND C3/A501. ALTERNATE #2		
12	EXISTING COUNTER FLASHING AROUND THE SECOND STORY WOOD CONSTRUCTED AREA TO BE REMOVED AND REPLACED. ALTERNATE #2		
13	EXISTING ASPHALT SHINGLES, DRIP EDGE, SOFFIT, AND FASCIA TO BE REMOVED AND REPLACED WITH NEW. GABLE END TO BE EXTENDED TO ACCEPT NEW SIDING. SEE DETAILS C1/A510 AND C3/A501. ALTERNATE #2		
16	REPAIR WOODEN STAIR IN THE ALLEYWAY. ALTERNATE #5		
17	DEMOLISH SINGLE STORY WOODEN ADDITION AT BASEMENT LEVEL. WORK TO INCLUDE: REMOVAL (TRAILER WITHIN STORAGE BUILDING AND WATERPROOFING OF NEW EXTERIOR WALL. ALTERNATE		
18	REPAIR EXISTING WOOD STAIR IN SAME LOCATION AS EXISTING. WORK TO INCLUDE NEW STRUCTURE FOR LANDINGS AND STAIR RUNS WHERE FORMER BUILDING PROVIDED STRUCTURE WAS REMOVED. ALTERNATE #6		

ARCHITECTURAL & ENGINEERING DESIGN ASSOCIATES, P.C.

1246 RT. 3 - P.O. BOX 762 PLATTSBURGH, NEW YORK, 12901 T: 518.562.1800 F:518.562.1702 E: JAA@AEDAPC.COM

COPYRIGHT® - ARCHITECUTRAL &
ENGINEERING DESIGN ASSOCIATES, P.C.
HAS THE EXCLUSIVE RIGHT TO
REPRODUCE THE WORK, TO MAKE
DERIVATIVE USE OF IT, TO GRANT LICENSES TO USE THE WORK, TO SELL THE WORK AND TO OTHERWISE DEAL WITH THE COPYRIGHT THROUGH THE

LIFE OF THE COPYRIGHT OWNER AND FOR 50 YEARS BEYOND (UNLESS NOTED OTHERWISE) - UNAUTHORIZED THIS DRAWING BEARING A LICENSED ARCHITECT'S OR ENGINEER'S SEAL IS A

ARCHITECTS OR ENGINEERS SEAL IS A VIOLATION OF SECTION 7209, SUBDIVISION 2, OF THE NEW YORK STATE EDUCATION LAW. ONLY COPIES FROM THE ORIGINAL OF THIS DRAWING BEARING THE ORIGINAL ARCHITECT'S OR ENGINEER'S SEAL AND SIGNATURE SHALL BE CONSIDERED VALID TRUE COPIES.

OF PLATTSBURGH - DRI NTOWN GRANT PROGRAM CITY

CONSTRUCTION DOCUMENT PHASE

SERVICES 90% CONSTRUCTION

REVISIONS

BY DATE

EXTERIOR **ELEVATIONS &** PHOTOS

PROJECT NO. 09-08-21 DRAWN BY CHECKED BY



14

B1 INTERIOR VIEW OF STOREFRONT N.T.S.

INCLUDES ALTERNATE #2 AND #6

D1 STAIRS @ SINGLE STORY WOODEN STRUCTURE

N.T.S.

B2 CHARRED TRUSSES

INCLUDES ALTERNATES #3 AND #4

B4 MODIFIED TRUSS
N.T.S.

INCLUDES ALTERNATE #3 AND #4

D2 STORAGE TRAILER

INCLUDES ALTERNATE #6

D3 **ELECTRICAL PANELS**1/4" = 1'-0"

KEYNOTES

VALUE KEYNOTE TEXT REMOVE AND REPLACE STOREFRONT SYSTEM AND FIRST FLOOR FACADE, TO INCLUDE BOTH ENTRY DOORS. WORK TO ALSO INCLUDE FRAMED WALL & SIGN ABOVE EXISTING STOREFRONT. REPLACEMENT STOREFRONT TO BE SIMILAR TO ORIGNAL DESIGN WITH RESPECT TO HISTORICAL PRESERVATION AND 33 BRIDGE STREET WHICH HAS RECENTLY BEEN RECONSTRUCTED, SEE DIAGRAM D4/A203 FOR STYLE AND DESIGN. REPLACE DOORS, DOOR FRAMES AND TRANSOM WINDOW WITH MATERIALS SIMILAR TO ORIGINAL, REVIEW

ENTIRETY OF EXISTING FRAMED WALL & SIGN ABOVE STOREFRONT TO BE REMOVED. SIGN TO BE TURNED OVER TO OWNER. NEW STOREFRONT TO BE NEW LIGHTING AND POWER TO BE INSTALLED AT NEW STOREFRONT

ENTRANCE. INSTALL NEW METAL WALL PANEL SYSTEM AT WOODEN CONSTRUCTED AREAS ON THE SECOND AND THIRD FLOOR. SEE DETAILS C1/A510 AND C3/A501. ALTERNATE #2

EXISTING DAMAGED, CHARRED, AND MODIFIED TRUSSES TO BE REINFORCED WITH NEW SIMILAR TRUSSES. ALTERNATE #3 REMOVE EXISTING FLOORING AND EXPOSE EXISTING STRUCTURE. INSTALL NEW FLOOR FRAMING IN BETWEEN EXISTING MEMBERS TO ELIMINATE THE SLOPE IN THE FLOOR. INSTALL NEW 3/4" TONGUE AND GROOVE PLYWOOD SUBFLOOR AND LUXURY LAMINATE FLOORING. ALTERNATE #4

DEMOLISH SINGLE STORY WOODEN ADDITION AT BASEMENT LEVEL. WORK TO INCLUDE: REMOVAL OF TRAILER WITHIN STORAGE BUILDING AND WATERPROOFING OF NEW EXTERIOR WALL. ALTERNATE #6 REPAIR EXISTING WOOD STAIR IN SAME LOCATION AS EXISTING. WORK TO INCLUDE NEW STRUCTURE FOR LANDINGS AND STAIR RUNS WHERE FORMER BUILDING PROVIDED STRUCTURE WAS REMOVED. ALTERNATE #6 REMOVE EXISTING ELECTRICAL PANELS ABANDONED FROM DEMOLITION.

INSTALL NEW ELECTRICAL PANEL WITHIN THE BASEMENT LEVEL, COORDINATE LOCATION WITH OWNER. PANEL WILL BE REQUIRED TO BE REWIRED BACK TO EXISTING METER LABELED #1. DISTRIBUTION WIRING FROM EXISTING PANEL TO BE TERMINATED AND REMOVED. ALL ELECTRICAL WORK TO CONFORM TO 2020 BUILDING CODE OF NEW YORK STATE, CHAPTER 27, NFPA 70, & N.E.C. 2017. ALTERNATE #6

ARCHITECTURAL & ENGINEERING DESIGN ASSOCIATES, P.C. 1246 RT. 3 - P.O. BOX 762

PLATTSBURGH, NEW YORK, 12901 T: 518.562.1800 F:518.562.1702 E: JAA@AEDAPC.COM COPYRIGHT© - ARCHITECUTRAL &

ENGINEERING DESIGN ASSOCIATES, P.O. HAS THE EXCLUSIVE RIGHT TO REPRODUCE THE WORK, TO MAKE DERIVATIVE USE OF IT, TO GRANT LICENSES TO USE THE WORK, TO SELL THE WORK AND TO OTHERWISE DEAL WITH THE COPYRIGHT THROUGH THE LIFE OF THE COPYRIGHT OWNER AND FOR 50 YEARS BEYOND (UNLESS NOTED OTHERWISE) - UNAUTHORIZED

THIS DRAWING BEARING A LICENSED ARCHITECT'S OR ENGINEER'S SEAL IS A VIOLATION OF SECTION 7209, SUBDIVISION 2, OF THE NEW YORK STATE EDUCATION LAW. ONLY COPIES FROM THE ORIGINAL OF THIS DRAWING BEARING THE ORIGINAL ARCHITECT'S OR ENGINEER'S SEAL AND SIGNATURE SHALL BE CONSIDERED VALID TRUE COPIES.

OF PLATTSBURGH - DRI NTOWN GRANT PROGRAM

CITY CONSTRUCTION DOCUMENT PHASE



BY DATE

REVISIONS

INTERIOR **ELEVATIONS &** PHOTOS

09-08-21 CHECKED BY

INCLUDES ALTERNATES #6 AND #7



ARCHITECTURAL & ENGINEERING DESIGN ASSOCIATES, P.C. 1246 RT. 3 - P.O. BOX 762 PLATTSBURGH, NEW YORK, 12901 T: 518.562.1800 F:518.562.1702 E: JAA@AEDAPC.COM

COPYRIGHT© - ARCHITECUTRAL & ENGINEERING DESIGN ASSOCIATES, P.C.

HAS THE EXCLUSIVE RIGHT TO REPRODUCE THE WORK, TO MAKE DERIVATIVE USE OF IT, TO GRANT LICENSES TO USE THE WORK, TO SELL THE WORK AND TO OTHERWISE DEAL WITH THE COPYRIGHT THROUGH THE LIFE OF THE COPYRIGHT OWNER AND FOR 50 YEARS BEYOND (UNLESS NOTED OTHERWISE) - UNAUTHORIZED ALTERATIONS AND/OR ADDITIONS TO THIS DRAWING BEARING A LICENSED ARCHITECT'S OR ENGINEER'S SEAL IS A VIOLATION OF SECTION 7209, SUBDIVISION 2, OF THE NEW YORK STATE

EDUCATION LAW. ONLY COPIES FROM THE ORIGINAL OF THIS DRAWING ENGINEER'S SEAL AND SIGNATURE SHALL BE CONSIDERED VALID TRUE COPIES.

OF PLATTSBURGH - DRI NTOWN GRANT PROGRAM CITY

CONSTRUCTION PHASE

DOCUMENT SERVICES 90%

CONSTRUCTION


REVISIONS # BY DATE


PROPOSED DESIGN


18035-006

09-08-21 DRAWN BY SEC CHECKED BY

A203

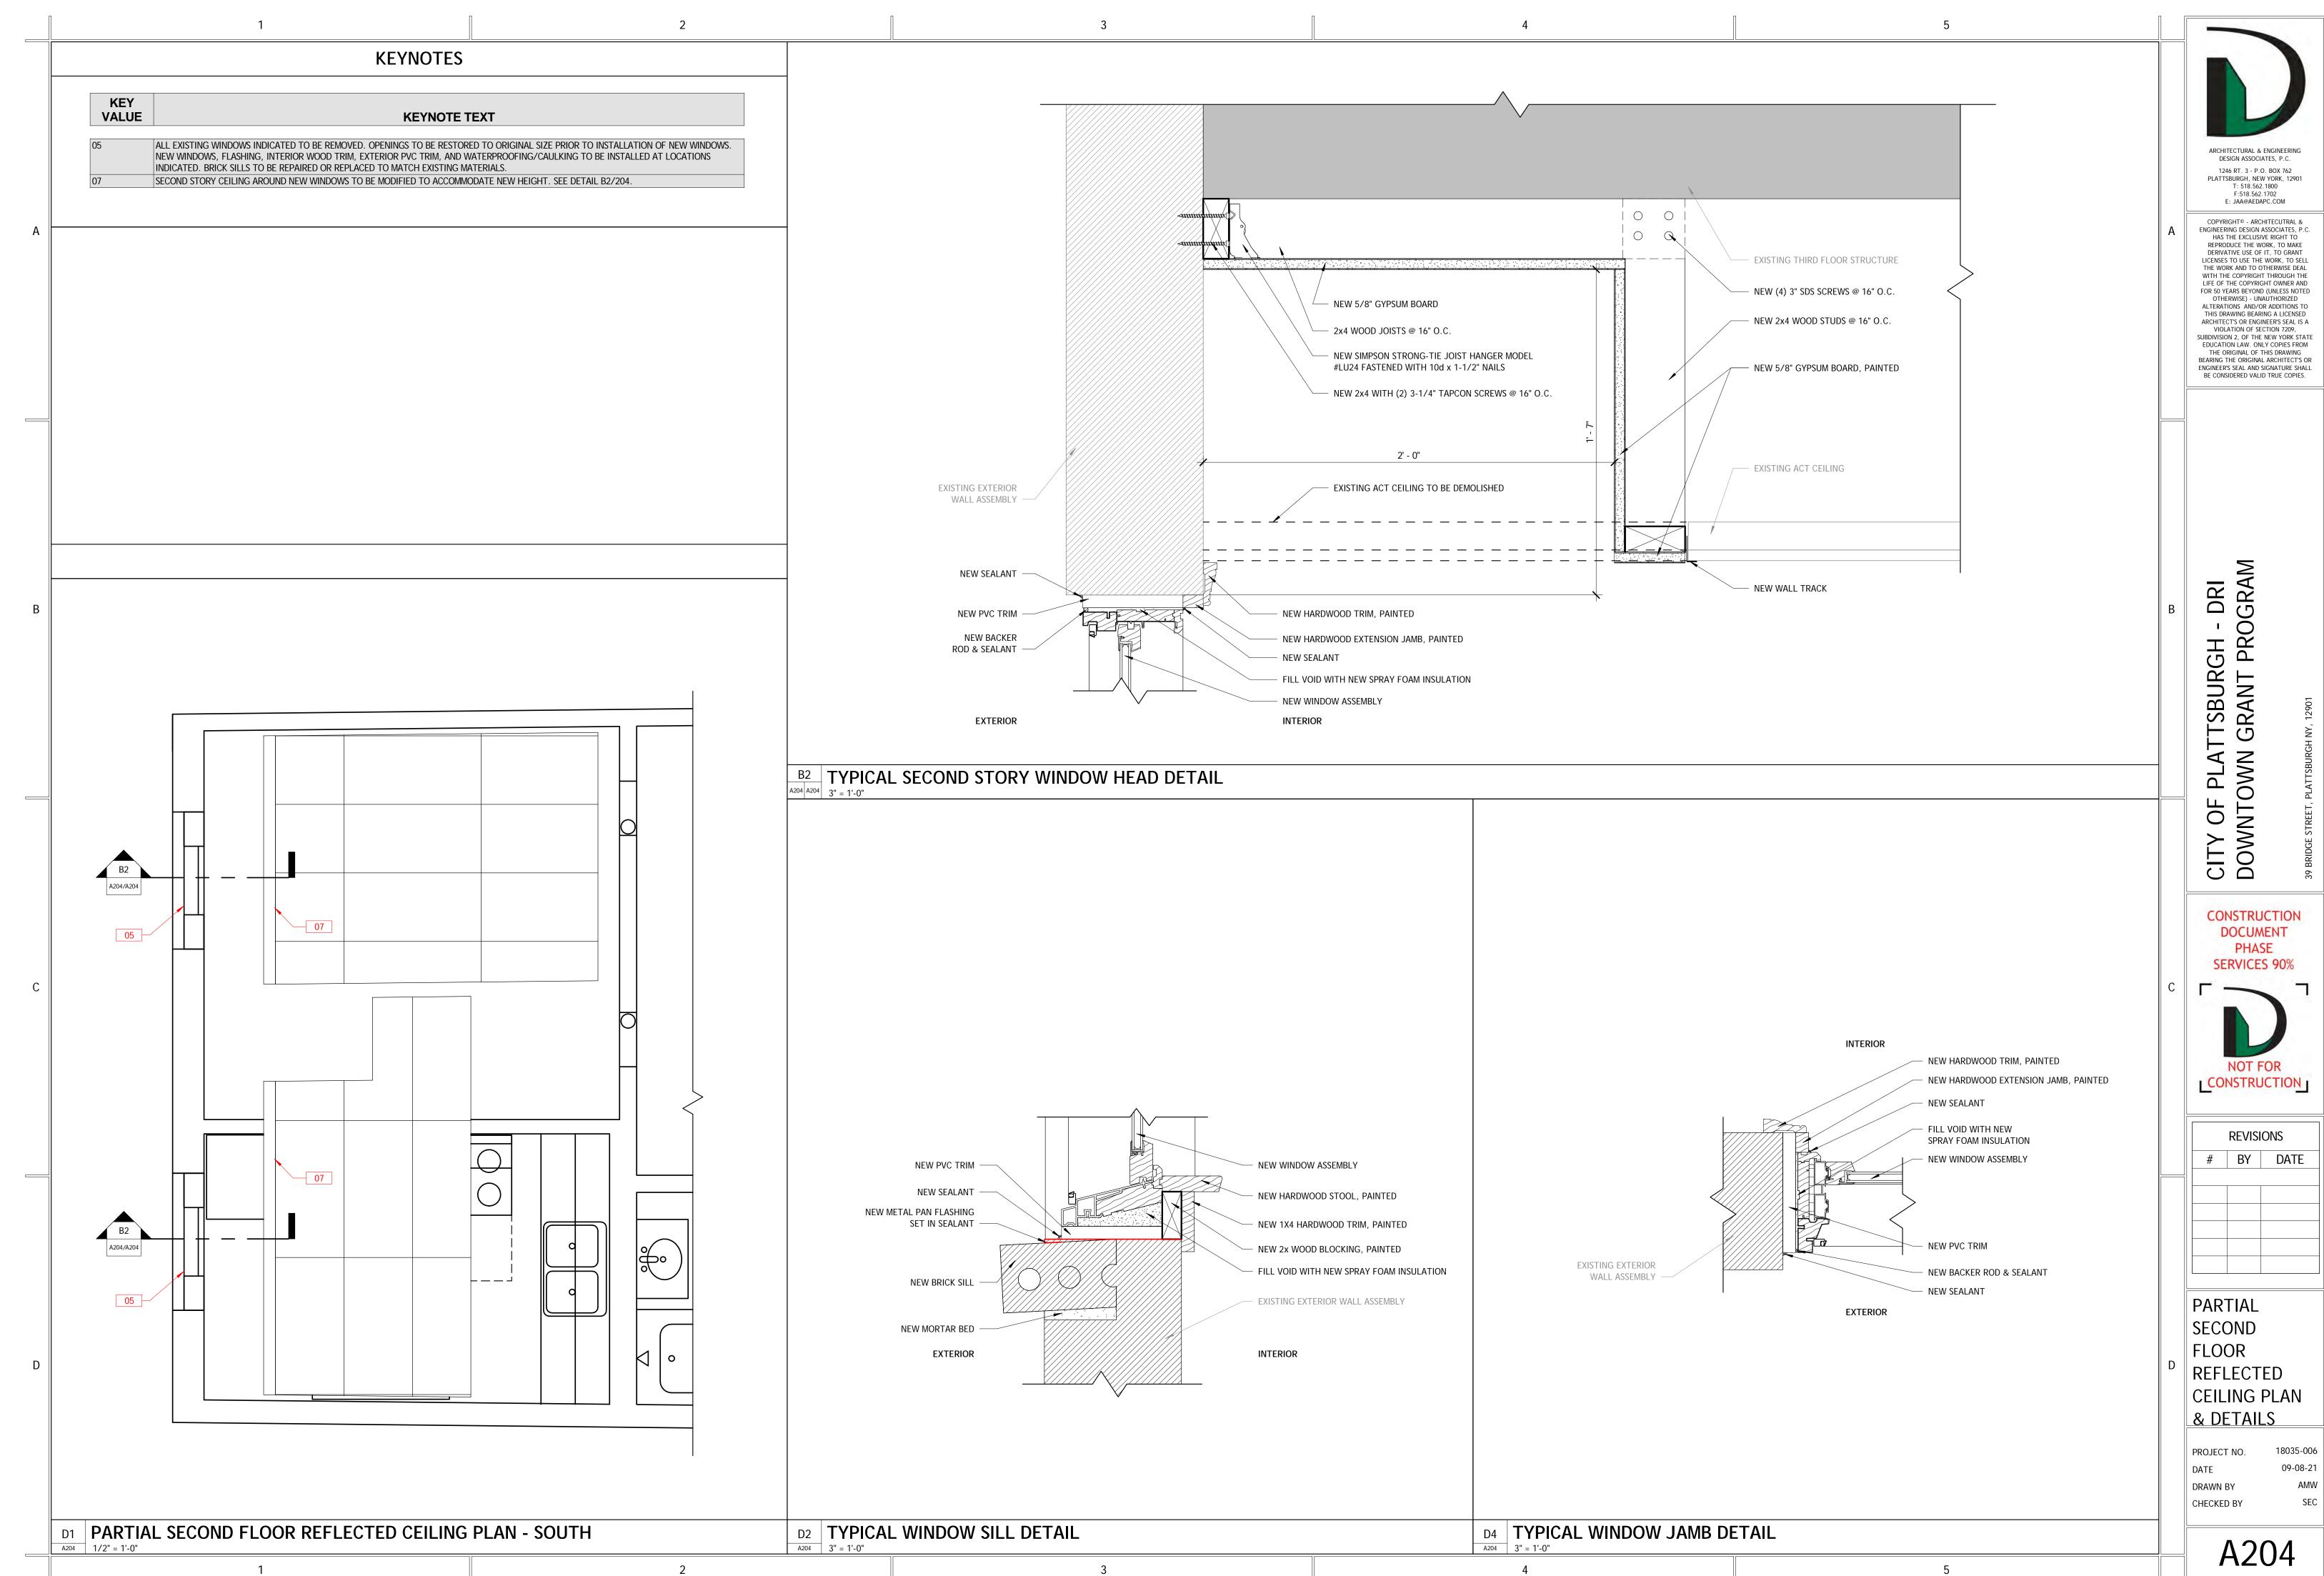

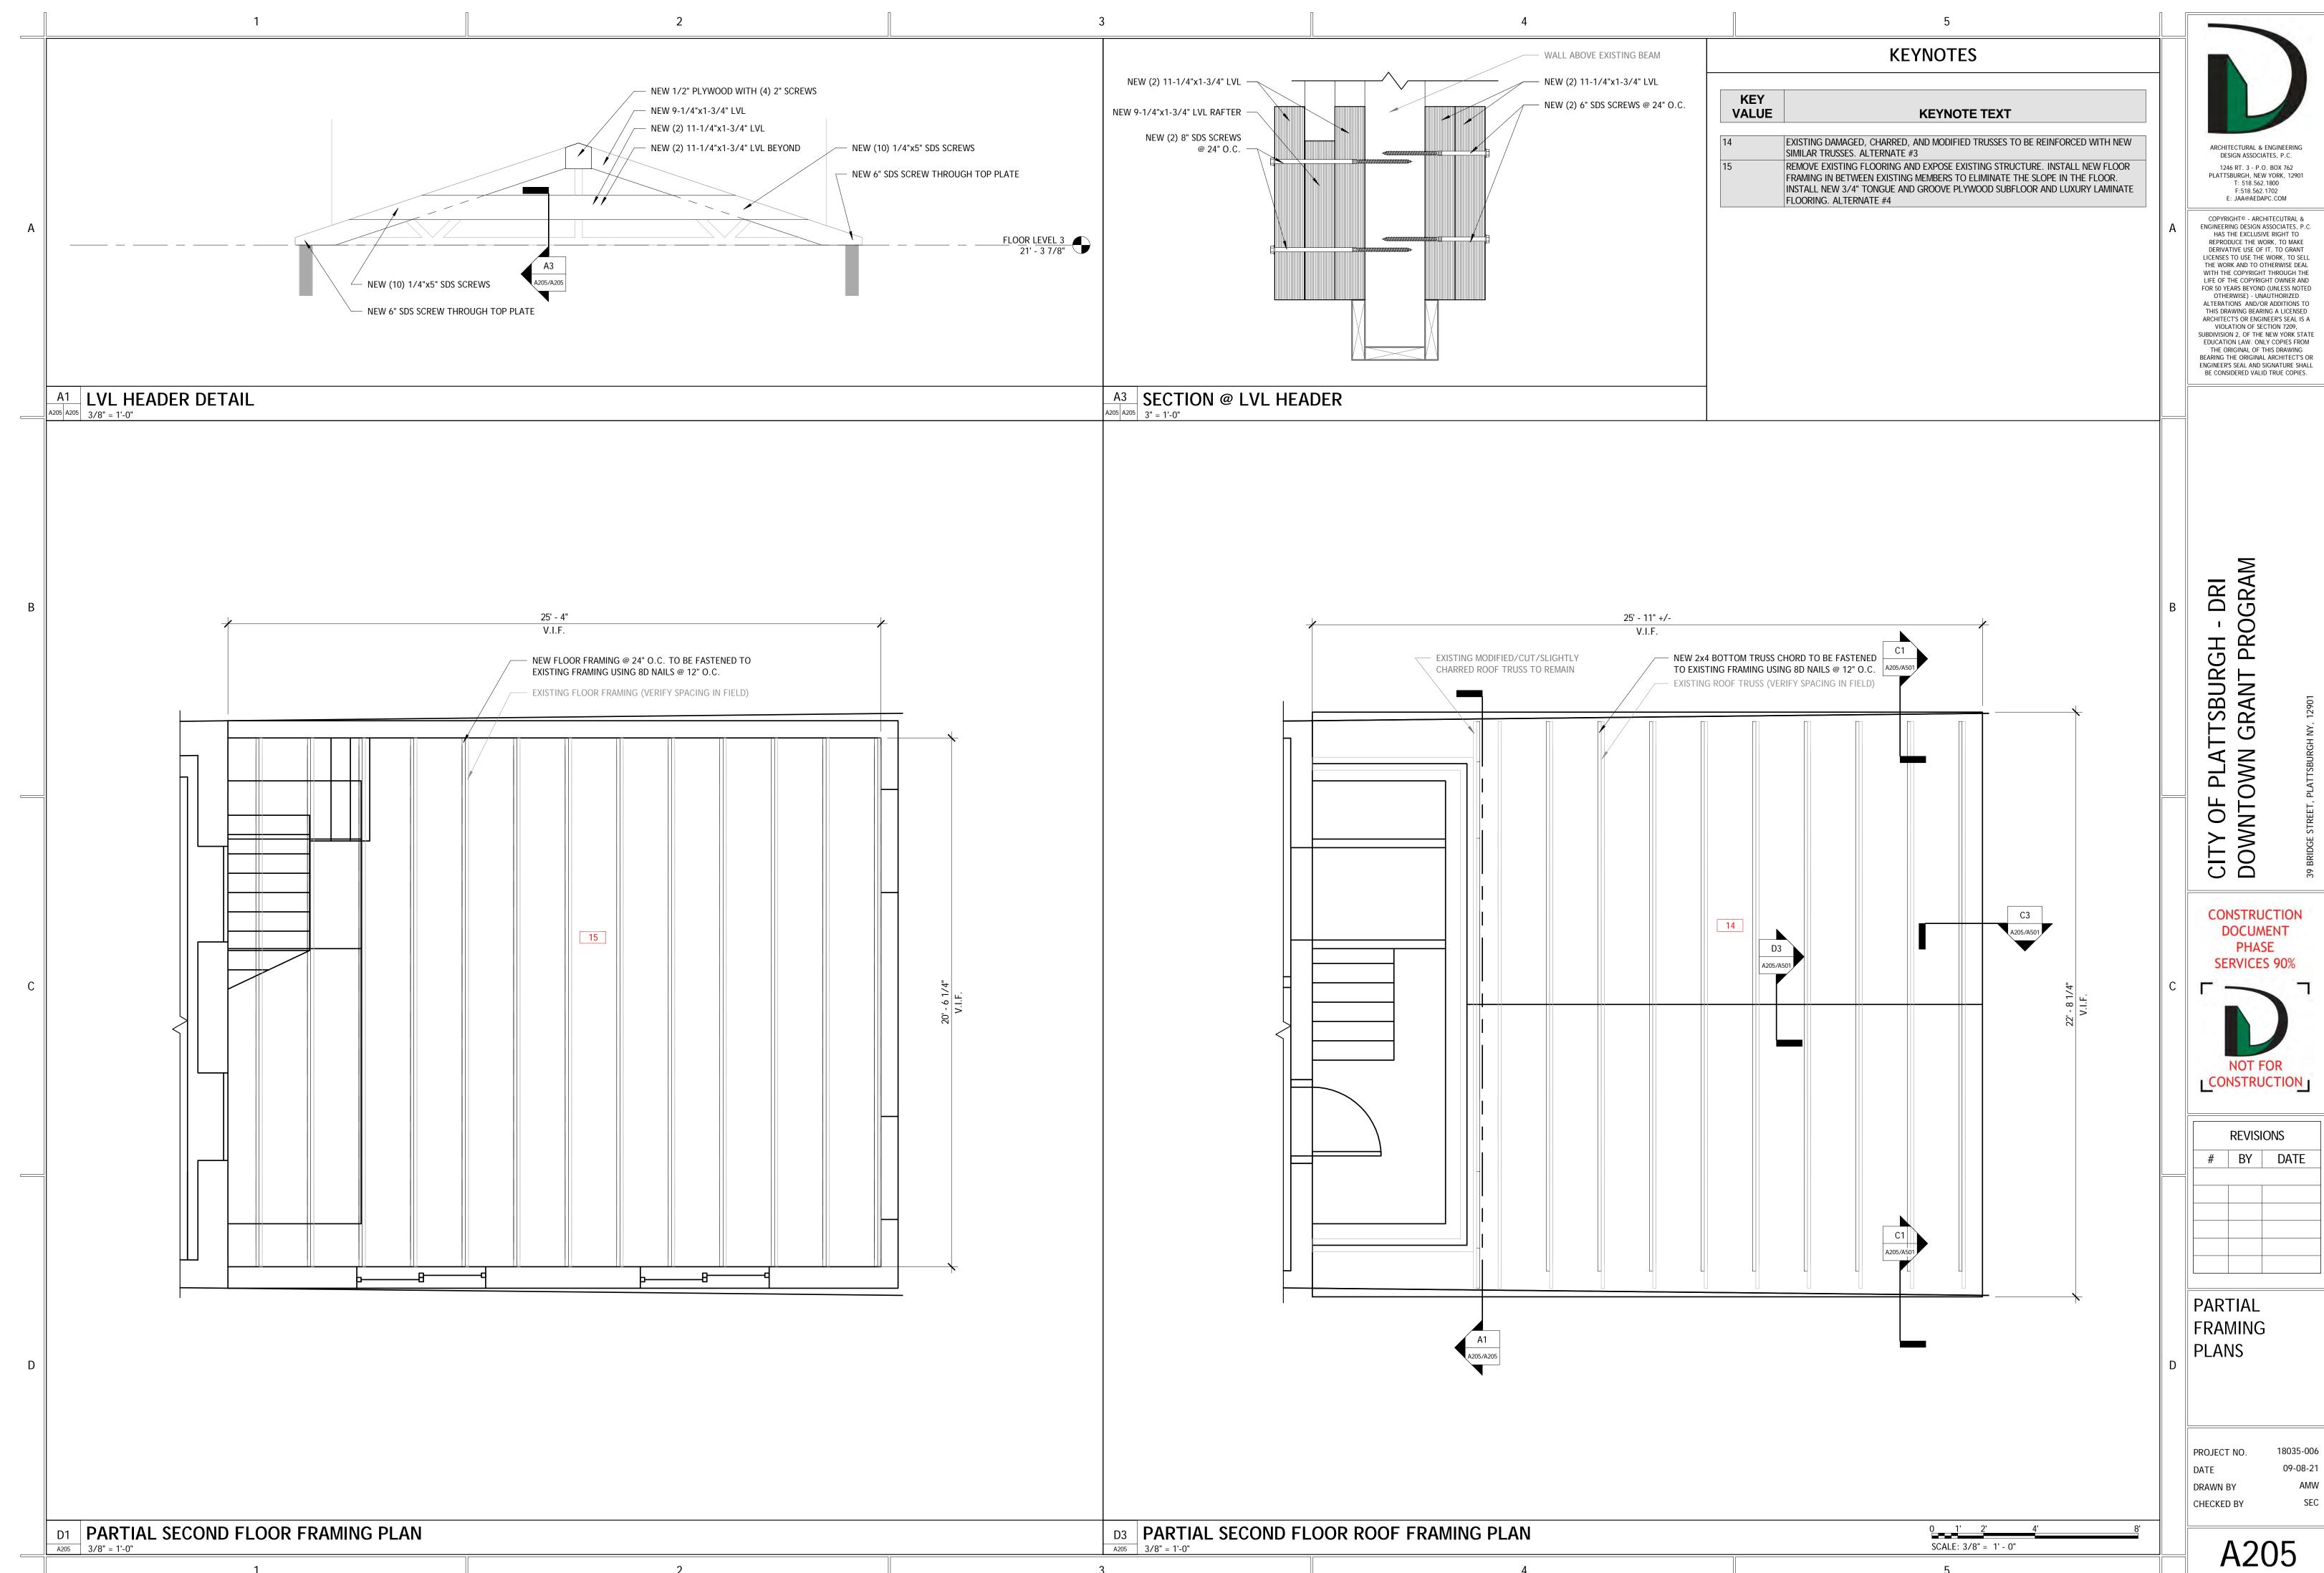

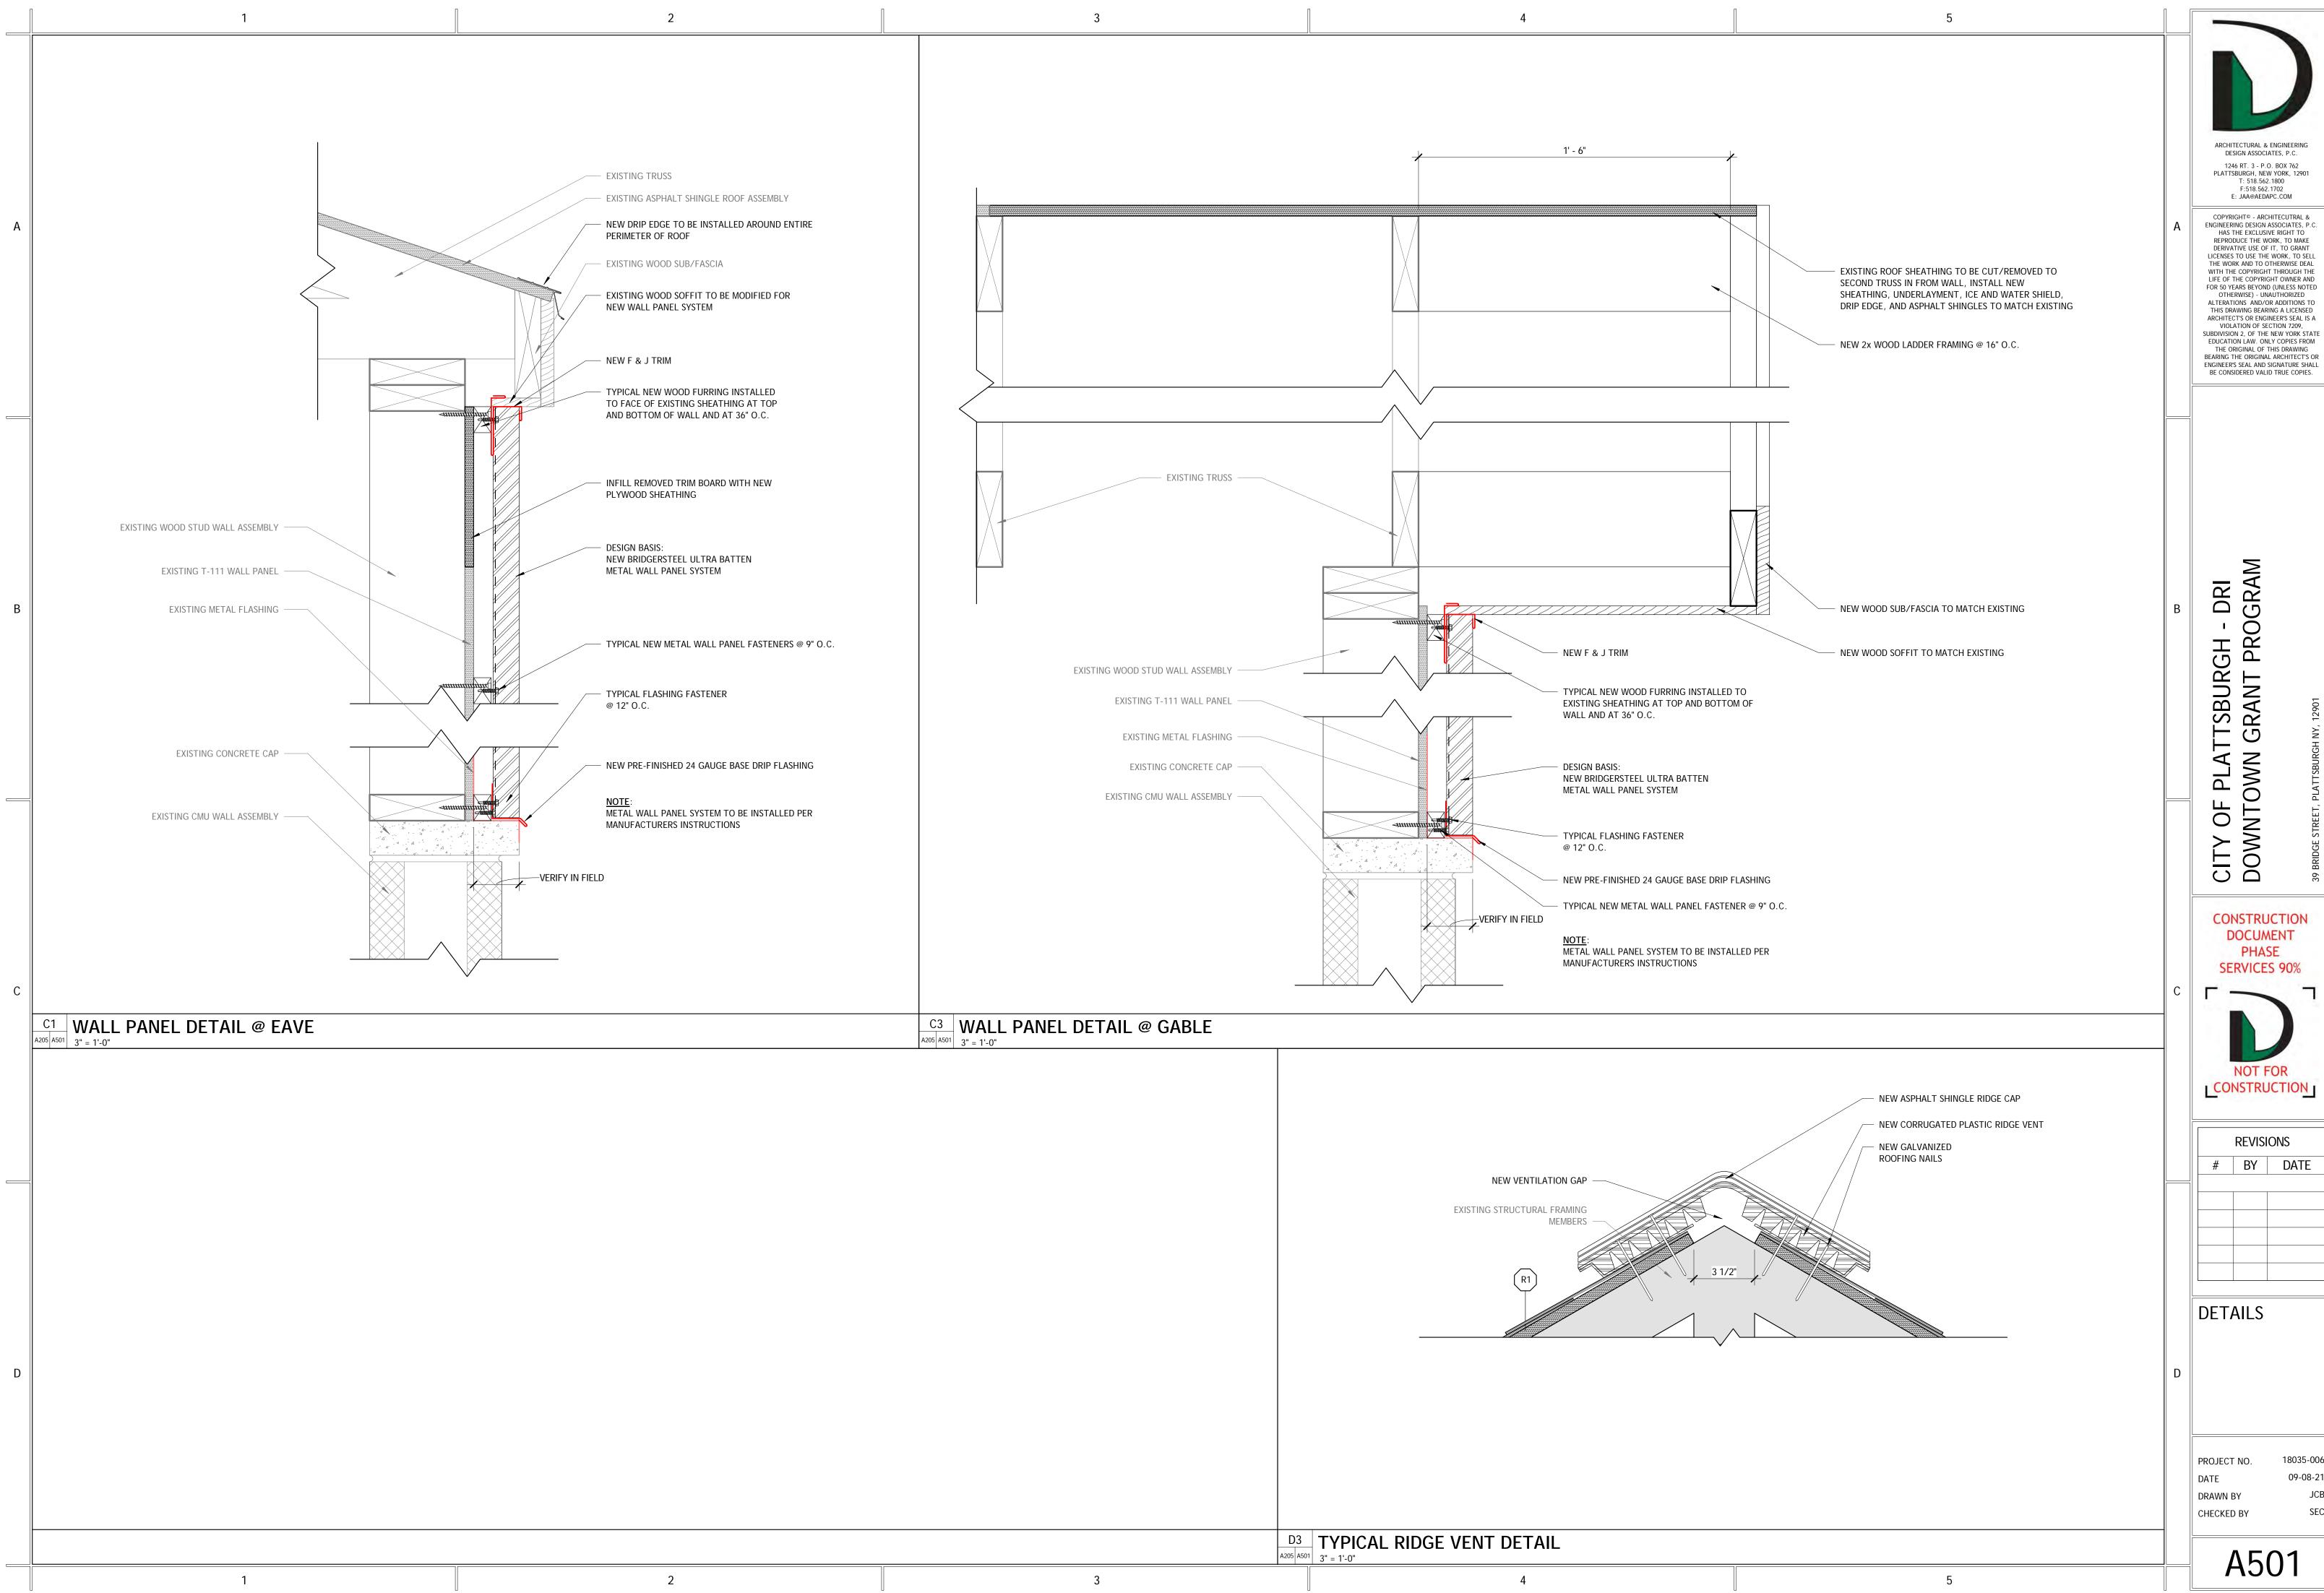

A501

09-08-21

JCB

